Sheet Title:
ARCHITECTURAL
SITE PLAN


Job No. 15005


Date: 09/18/15

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Sheet No:



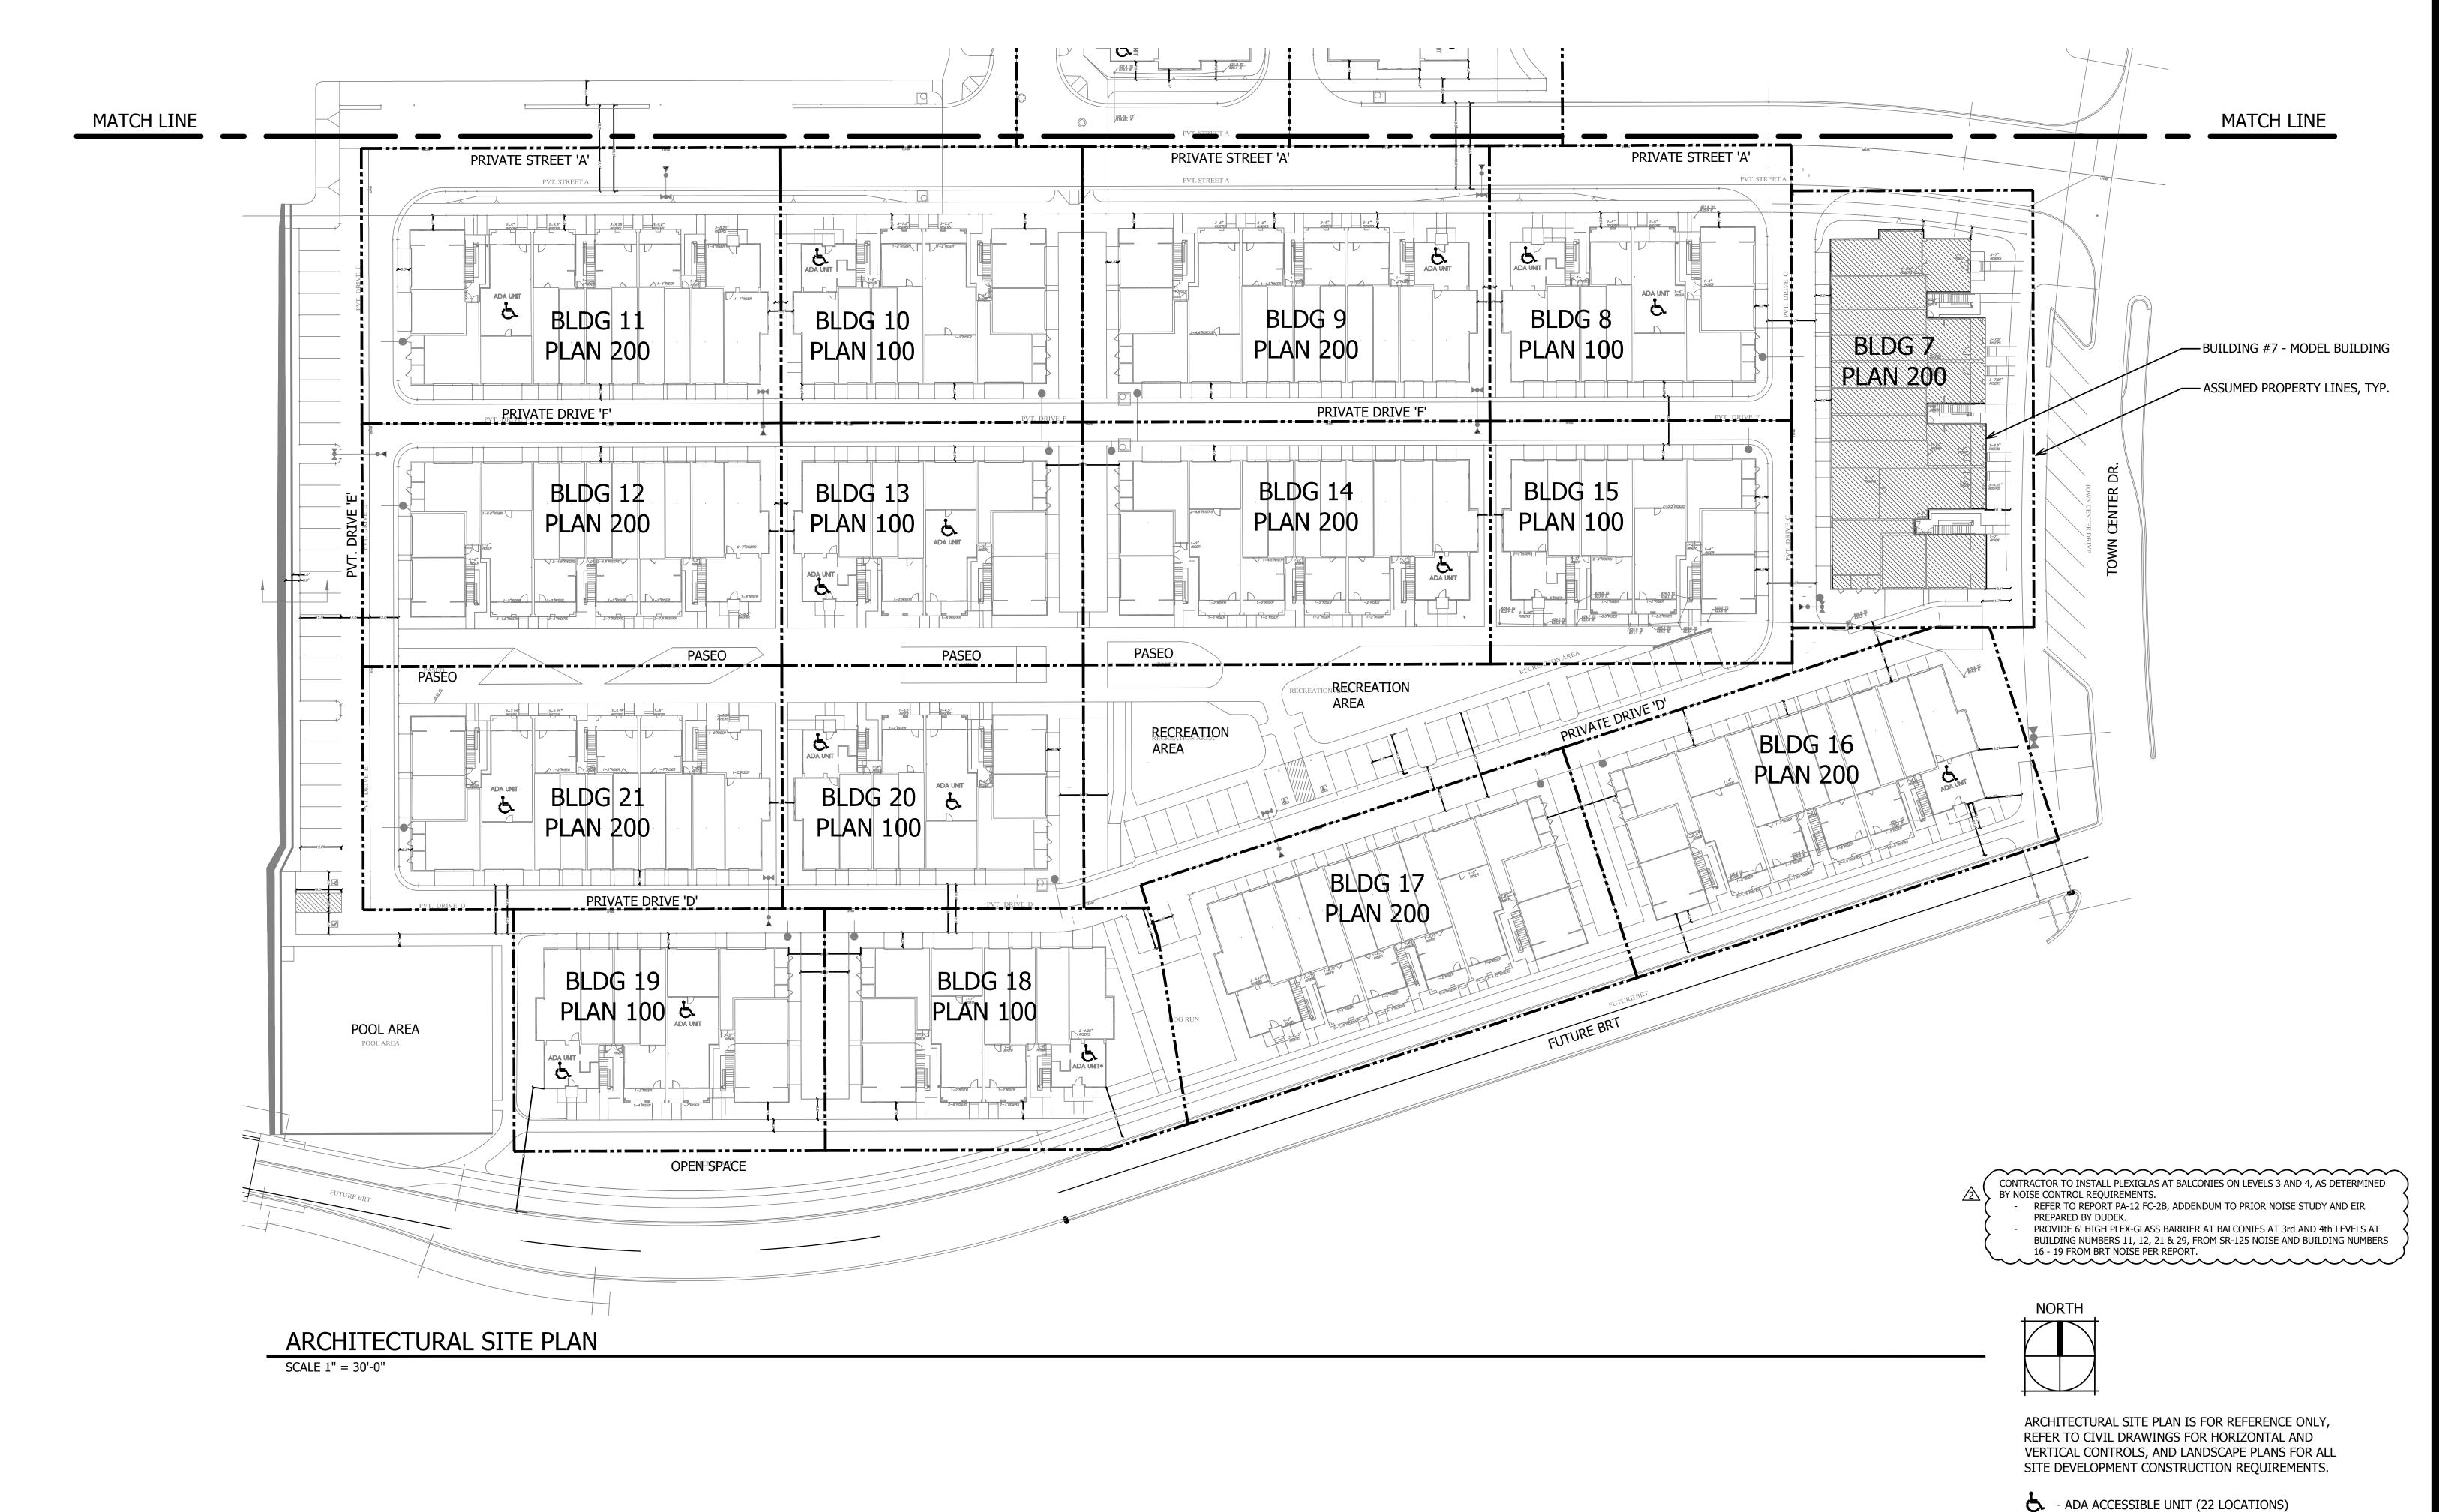

BLDG 100 - THIRD FLOOR PLAN
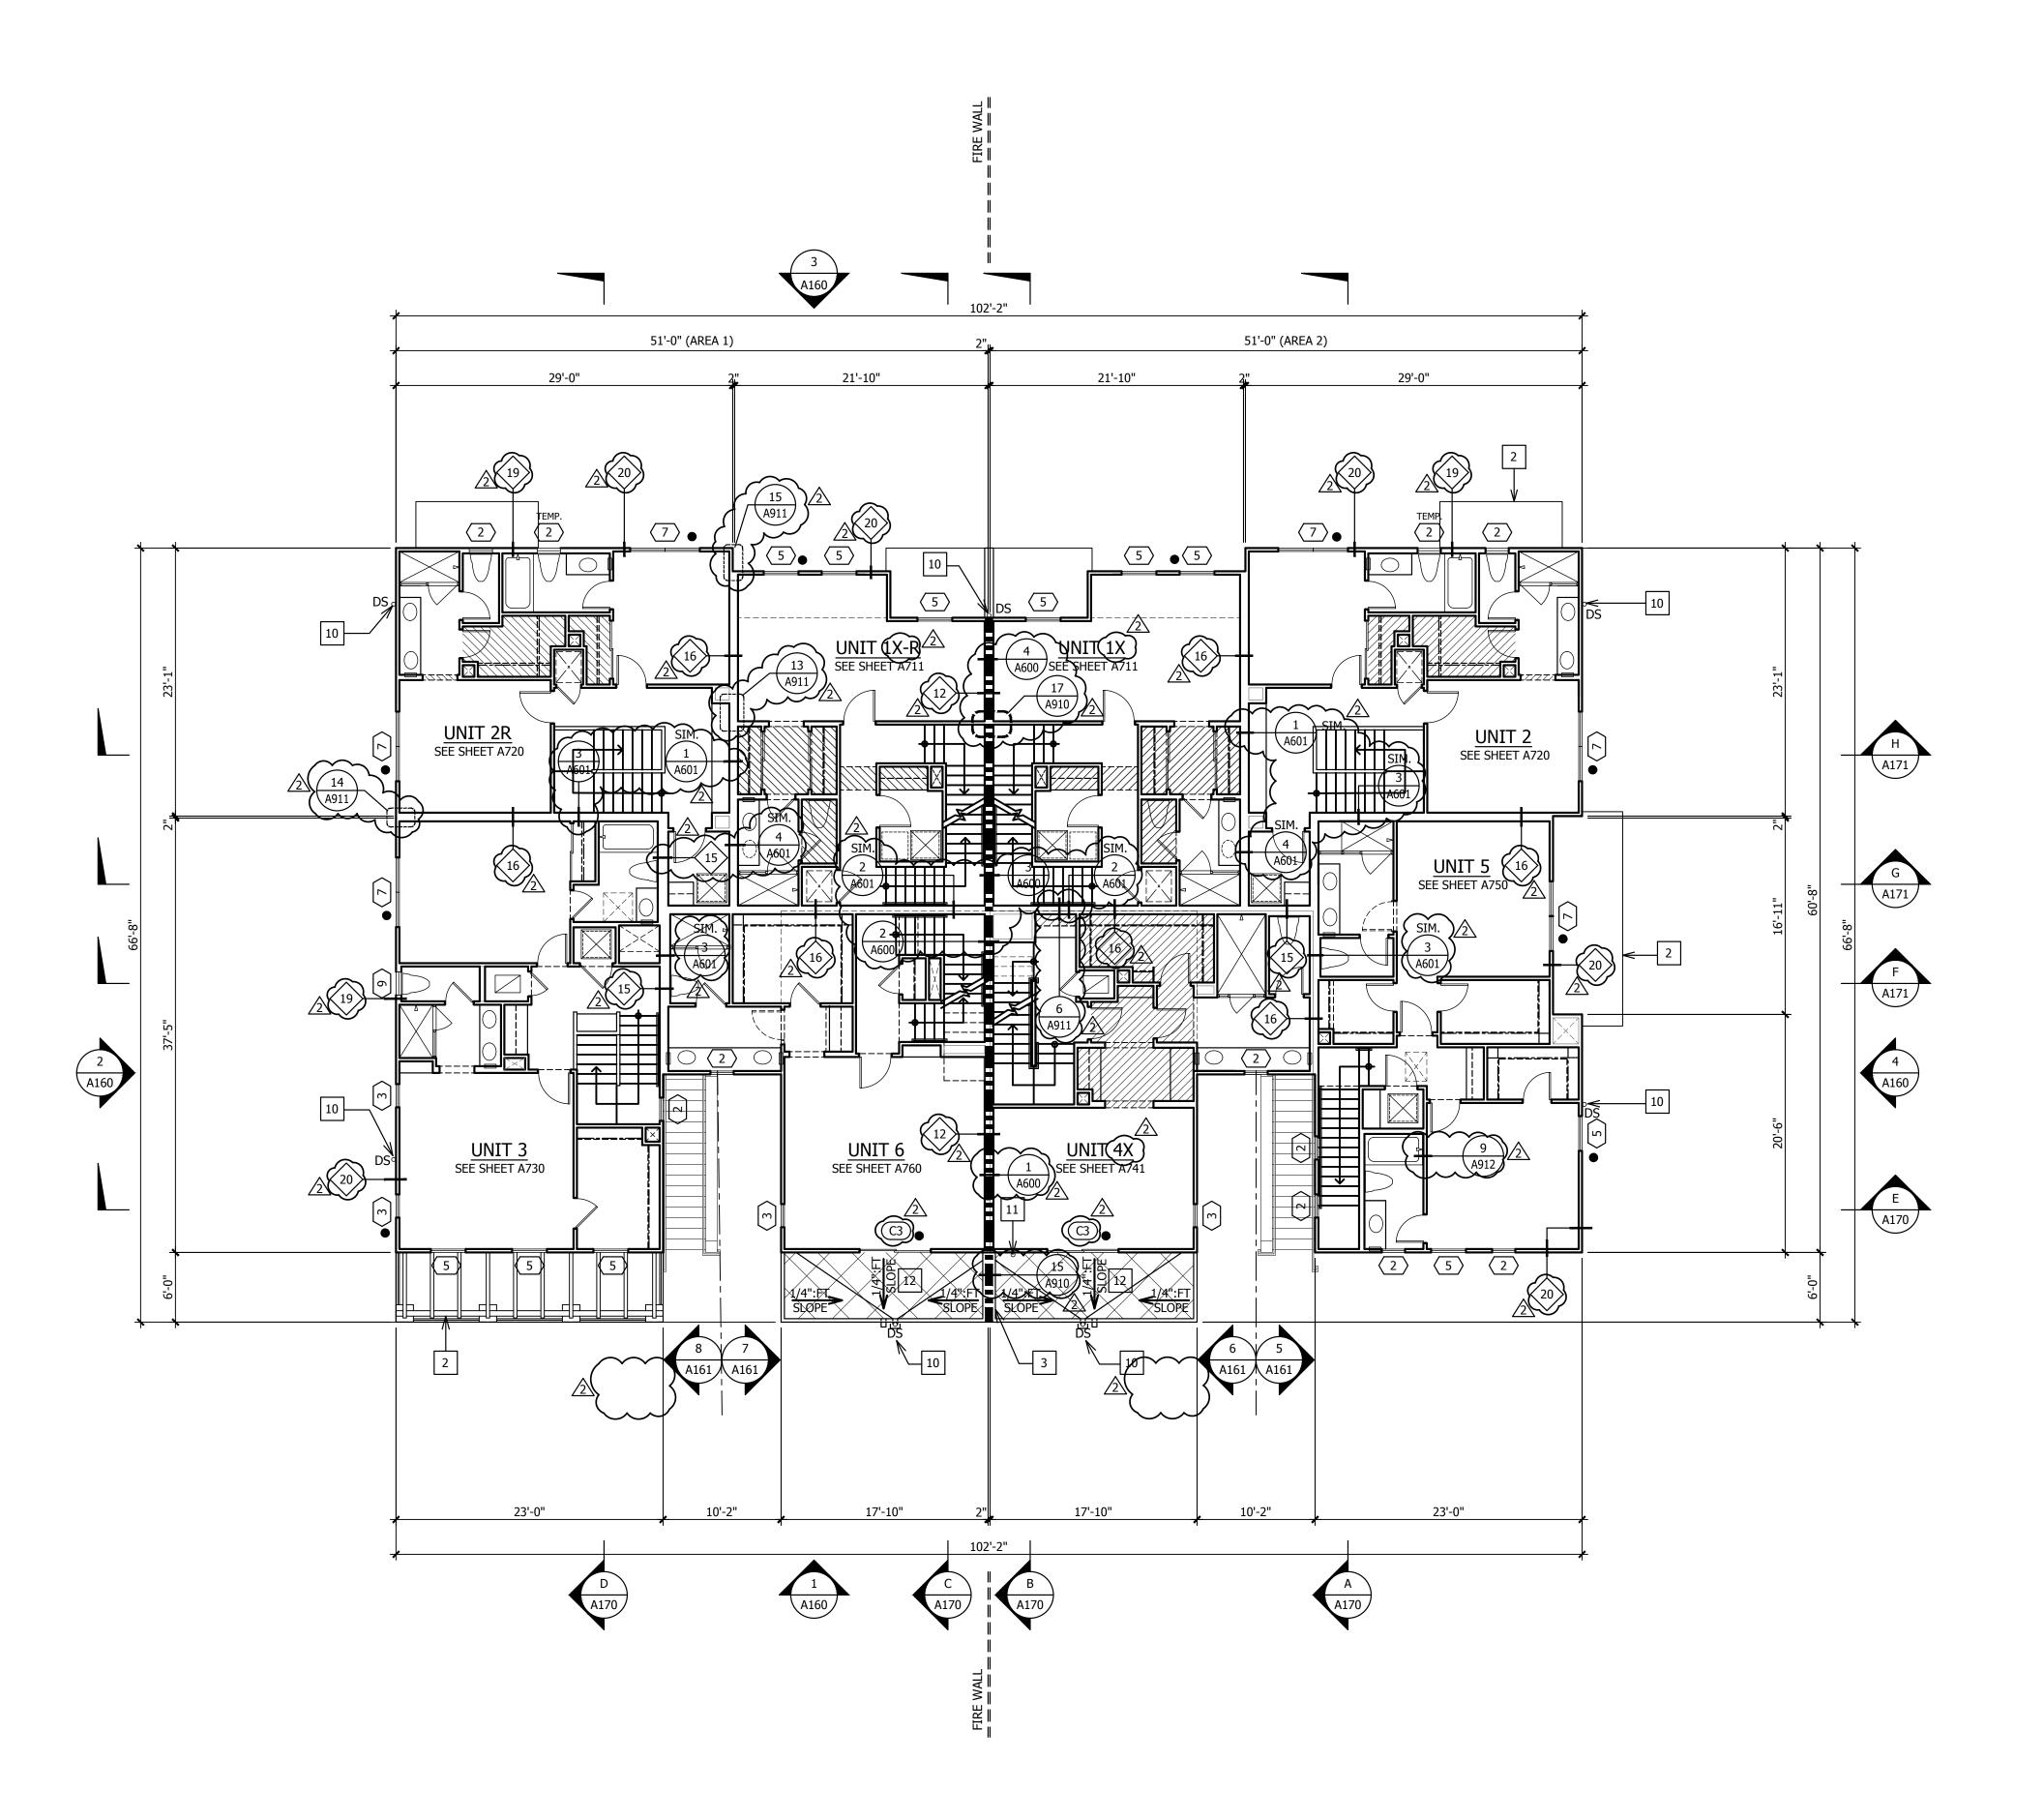
#### PLAN NOTES

SEE GENERAL NOTES, SHEET GN, FOR TYPICAL REQUIREMENTS. REFER TO 1/4" UNIT PLANS FOR TYPICAL NOTES, DIMENSIONS, REFERENCES AND INTERIOR WALL ASSEMBLY TYPES. SEE DRAWINGS BY OTHERS FOR ELECTRICAL, PLUMBING AND HVAC. ALL DIAGONAL WALLS TO BE 45, UNLESS NOTED OTHERWISE. ALL EXTERIOR WALLS TO BE 2X6, U.N.O. SEE DETAIL 12/A960 FOR TYPICAL INTERIOR DOOR HEAD AND JAMB. FIRST FLOOR WINDOW HEAD HEIGHT: 8'-0" U.N.O. SECOND FLOOR WINDOW HEAD HEIGHT: 8'-0" U.N.O. THIRD FLOOR WINDOW HEAD HEIGHT: 8'-0" U.N.O.

1 LINE OF FLOOR OR ROOF ABOVE.

2 LINE OF WALL OR FLOOR BELOW.

3 LOW WALL, STUCCO CAP, ROUGH HEIGHT AS NOTED, SEE DETAIL #15/A951

4 FIRE BELL ALARM SIGNAL

5 GUARDRAIL, WROUGHT IRON, SEE DETAIL #8/AD213.

6 TANKLESS WATER HEATER.

7 TRASH/RECYCLE BINS.

8 ROOF ACCESS LADDER (SHIP LADDER STYLE)

DOWNSPOUT LOCATION, CONNECT TO STORM DRAIN, SEE DETAILS 14/A920, 22/A920 & PLUMBING PLANS

DOWNSPOUT LOCATION, EXPEL ON ROOF BELOW, SEE DETAIL #24/AD501 & PLUMBING PLANS

PRIVATE PATIO / TERRACE (DENOTED BY CROSSHATCH).

EXTERIOR STROBE PER CVFD DETAIL, MOUNTED 14'-0" ABOVE FINISH GRADE, WEATHERPROOF PER NEMA 4X

MULTI-FAMILY RESIDENTIAL KNOX BOX PER CVFD DETAIL

### **LEGEND**

9 NOT USED

# SEE WINDOW SCHEDULE, SHEET A800

(#) ● ADJACENT DOT DENOTES EGRESS WINDOW

# ADJACENT STAR DENOTES ROOFTOP MECHANICAL ACCESS WINDOW (22"x24" MIN CLEAR OPENING)

# SEE DOOR SCHEDULE, SHEET A800

# • ADJACENT DOT DENOTES EGRESS DOOR

# SEE WALL TYPE SCHEDULE, SHEET A810

TYPICAL ONE HOUR WALL CONSTRUCTION, UNPROTECTED OPENING ALLOWED

TYPICAL ONE HOUR FIRE PARTITION, PROTECTED

OPENINGS REQUIRED

TYPICAL ONE HOUR DWELLING UNIT SEPARATION, PARTY WALL CONSTRUCTION, DOUBLE STUD WALL

TWO HOUR FIRE WALL CONSTRUCTION, DOUBLE STUD WALL

PENETRATIONS OF FIRE WALLS SHALL BE PROTECTED WITH
THROUGH-PENETRATION FIRE STOPS AND MEMBRANE-PENETRATION FIRE
STOPS IN ACCORDANCE WITH CBC SECTION 714.

FEC SEMI-RECESSED FIRE EXTINGUISHER CABINET, SEE 16/A912

CONTRACTOR TO INSTALL PLEXIGLAS AT BALCONIES ON LEVELS 3 AND 4, AS DETERMINED BY NOISE CONTROL REQUIREMENTS.

- REFER TO REPORT PA-12 FC-2B, ADDENDUM TO PRIOR NOISE STUDY AND EIR

REFER TO REPORT PA-12 FC-2B, ADDENDUM TO PRIOR NOISE STUDY AND EIR PREPARED BY DUDEK.
 PROVIDE 6' HIGH PLEX-GLASS BARRIER AT BALCONIES AT 3rd AND 4th LEVELS AT BUILDING NUMBERS 11, 12, 21 & 29, FROM SR-125 NOISE AND BUILDING NUMBERS 16 - 19 FROM BRT NOISE PER REPORT.

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HERITAGE BUILDING & DEVELOPMENT 4350 EXECUTIVE DRIVE SUITE 305 SAN DIEGO, CA 92121

BUILDING & DIVELOPMENT

Revisions:

PLAN CHECK#

Sheet Title:
BLDG TYPE 100
THIRD FLOOR PLAN

CHULA VISTA BR16-0014 THROUGH 0017


Job No. 15005

Date: 09/18/15

Scale: 1/8" = 1'-0"

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BLDG 100 - FOURTH FLOOR PLAN

### **PLAN NOTES**

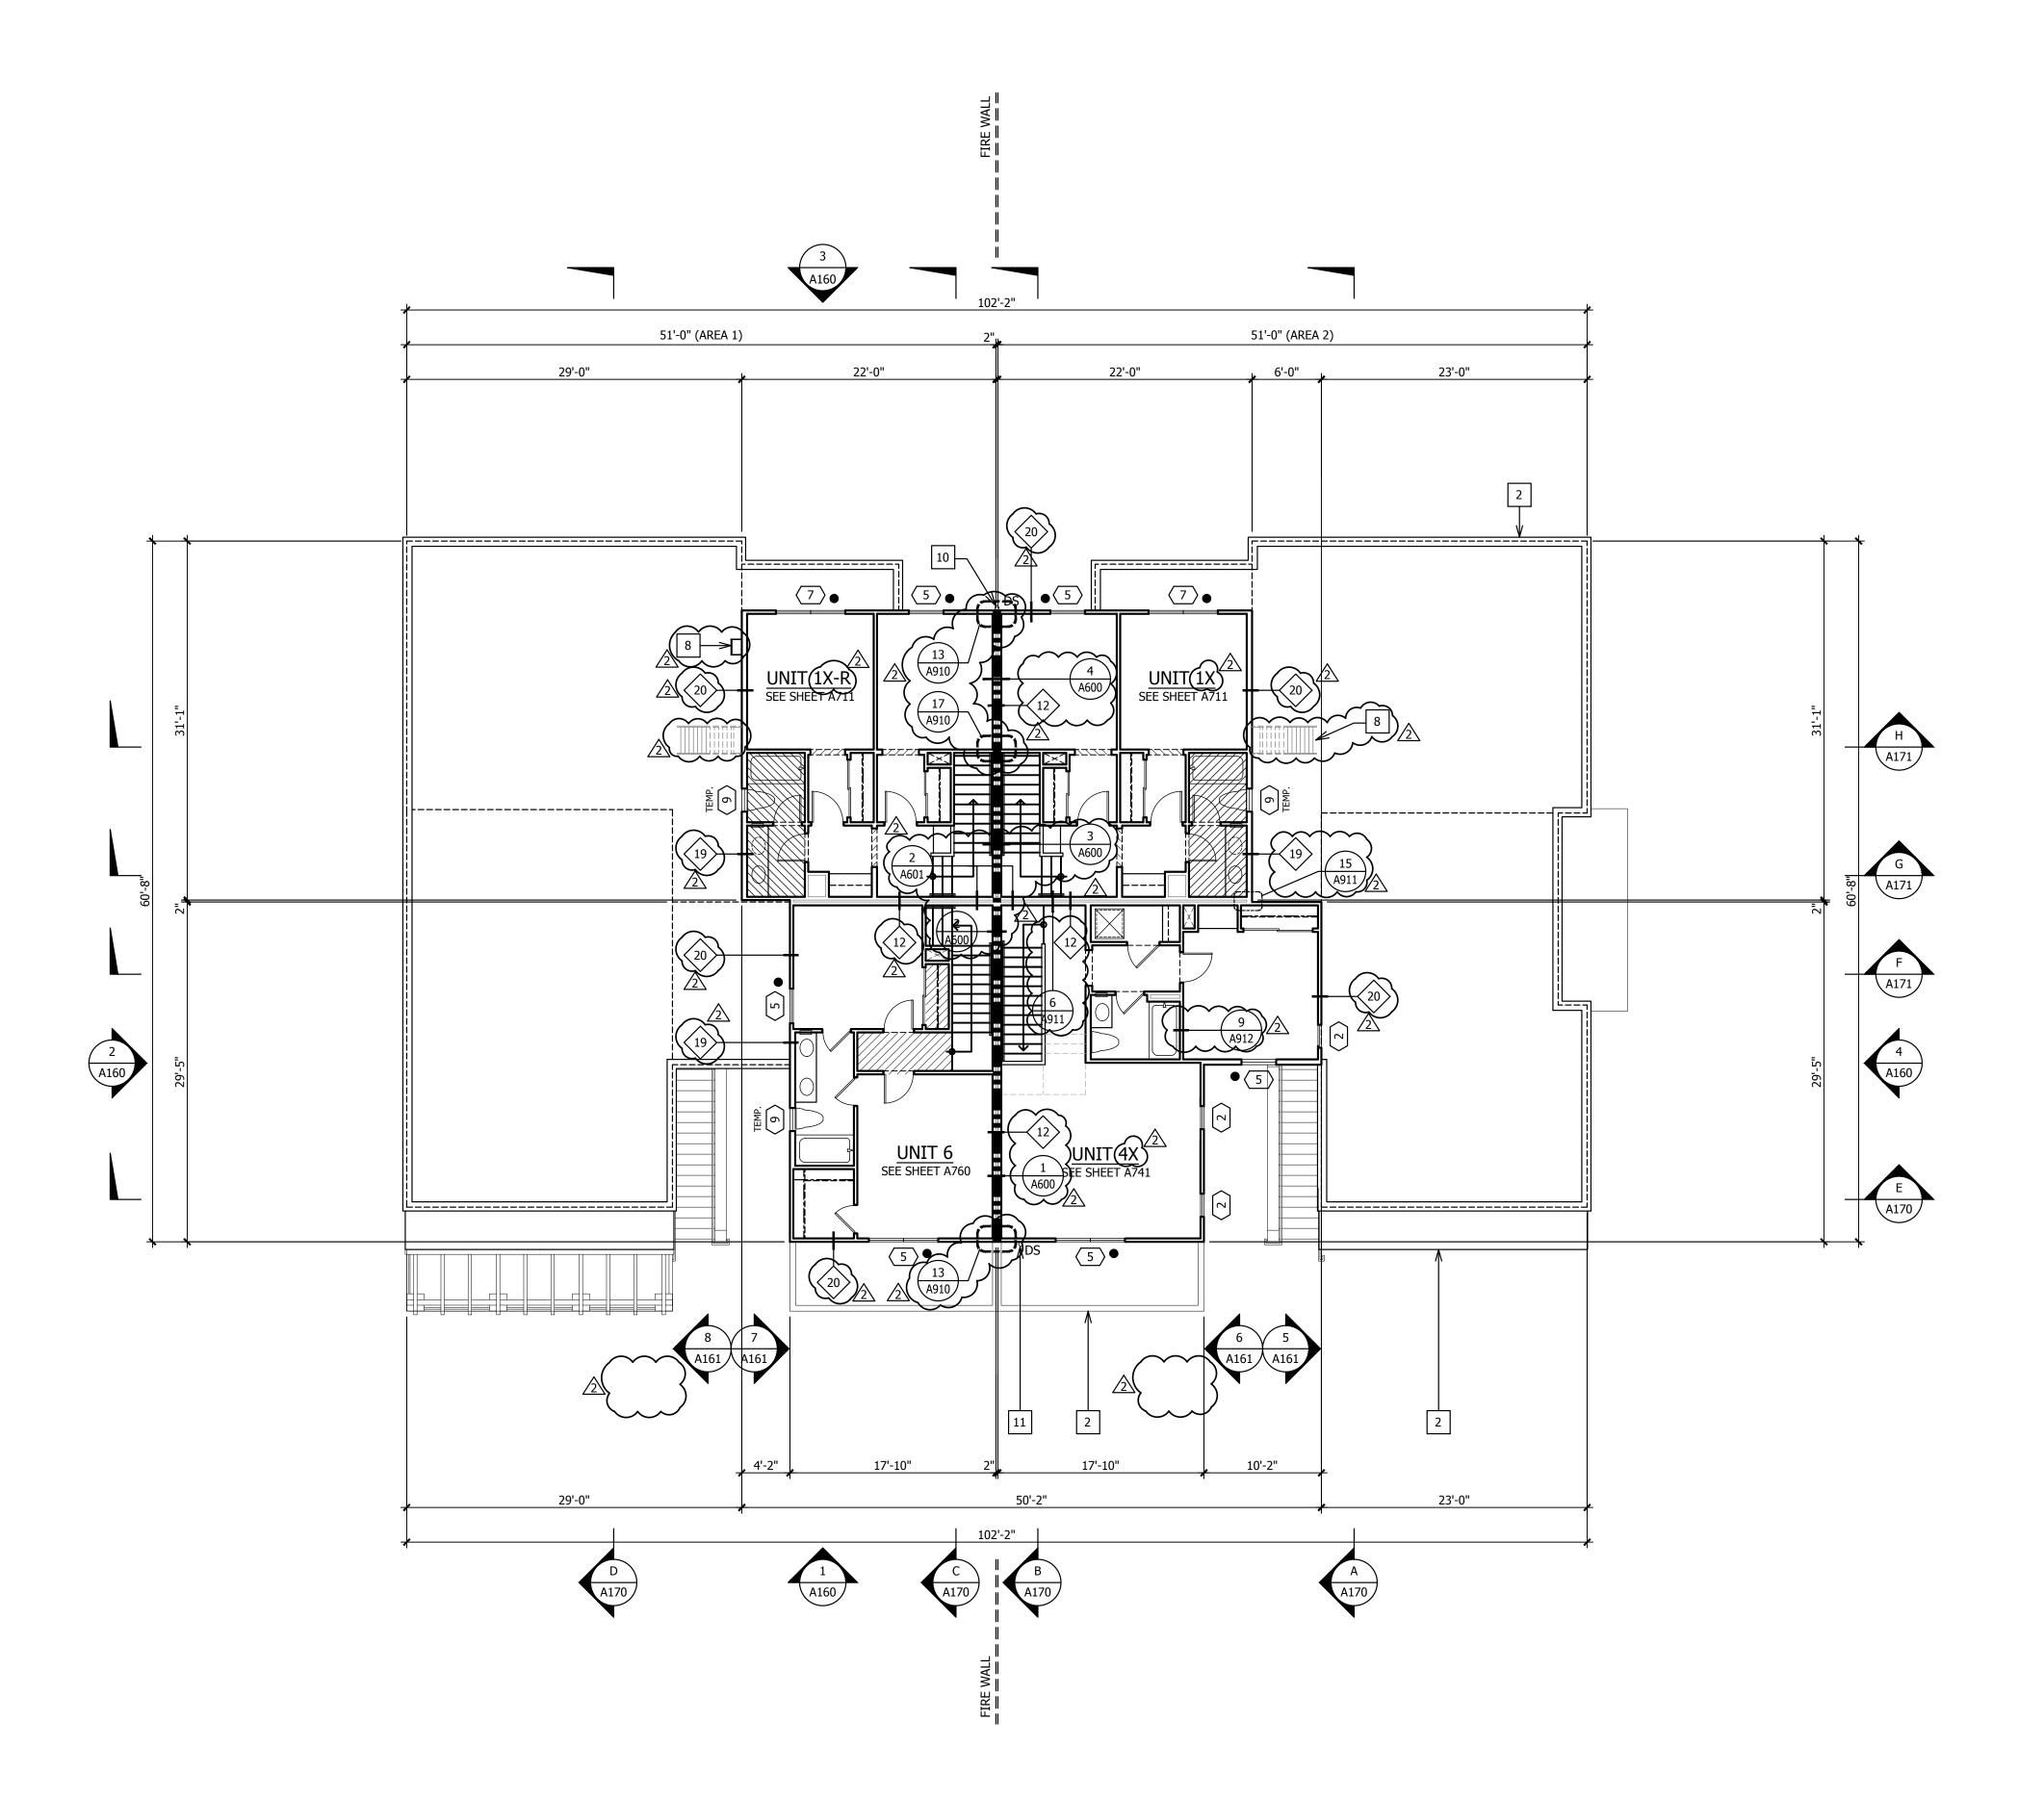SEE GENERAL NOTES, SHEET GN, FOR TYPICAL REQUIREMENTS. REFER TO 1/4" UNIT PLANS FOR TYPICAL NOTES, DIMENSIONS, REFERENCES AND INTERIOR WALL ASSEMBLY TYPES. SEE DRAWINGS BY OTHERS FOR ELECTRICAL, PLUMBING AND HVAC. ALL DIAGONAL WALLS TO BE 45, UNLESS NOTED OTHERWISE. ALL EXTERIOR WALLS TO BE 2X6, U.N.O. SEE DETAIL 12/A960 FOR TYPICAL INTERIOR DOOR HEAD AND JAMB. FIRST FLOOR WINDOW HEAD HEIGHT: 8'-0" U.N.O. SECOND FLOOR WINDOW HEAD HEIGHT: 8'-0" U.N.O. THIRD FLOOR WINDOW HEAD HEIGHT: 8'-0" U.N.O.

1 LINE OF FLOOR OR ROOF ABOVE.

2 LINE OF WALL OR FLOOR BELOW. 3 LOW WALL, STUCCO CAP, ROUGH HEIGHT AS NOTED, SEE DETAIL #15/A951 ( | 4 | FIRE BELL ALARM SIGNAL

5 GUARDRAIL, WROUGHT IRON, SEE DETAIL #8/AD213.

6 TANKLESS WATER HEATER.

7 TRASH/RECYCLE BINS.  $|\rangle$  8 ROOF ACCESS LADDER (SHIP LADDER STYLE) 9 NOT USED

DOWNSPOUT LOCATION, CONNECT TO STORM DRAIN, SEE DETAILS 14/A920, 22/A920 & PLUMBING PLANS

DOWNSPOUT LOCATION, EXPEL ON ROOF BELOW, SEE DETAIL #24/AD501 & PLUMBING PLANS

12 PRIVATE PATIO / TERRACE (DENOTED BY CROSSHATCH). EXTERIOR STROBE PER CVFD DETAIL, MOUNTED 14'-0" ABOVE FINISH GRADE, WEATHERPROOF PER NEMA 4X 14 MULTI-FAMILY RESIDENTIAL KNOX BOX PER CVFD DETAIL

### **LEGEND**

# SEE WINDOW SCHEDULE, SHEET A800

# • ADJACENT DOT DENOTES EGRESS WINDOW

# ADJACENT STAR DENOTES ROOFTOP MECHANICAL ACCESS WINDOW (22"x24" MIN CLEAR OPENING)

# SEE DOOR SCHEDULE, SHEET A800

# • ADJACENT DOT DENOTES EGRESS DOOR

# SEE WALL TYPE SCHEDULE, SHEET A810

TYPICAL ONE HOUR WALL CONSTRUCTION, UNPROTECTED OPENING ALLOWED TYPICAL ONE HOUR FIRE PARTITION, PROTECTED

OPENINGS REQUIRED TYPICAL ONE HOUR DWELLING UNIT SEPARATION, PARTY WALL CONSTRUCTION, DOUBLE STUD WALL

TWO HOUR FIRE WALL CONSTRUCTION, DOUBLE STUD WALL
PENETRATIONS OF FIRE WALLS SHALL BE PROTECTED WITH 🔼 THROUGH-PENETRATION FIRE STOPS AND MEMBRANE-PENETRATION FIRE  $^{f c}$ STOPS IN ACCORDANCE WITH CBC SECTION 714.

FEC SEMI-RECESSED FIRE EXTINGUISHER CABINET, SEE 16/A912

CONTRACTOR TO INSTALL PLEXIGLAS AT BALCONIES ON LEVELS 3 AND 4, AS DETERMINED BY NOISE CONTROL REQUIREMENTS. REFER TO REPORT PA-12 FC-2B, ADDENDUM TO PRIOR NOISE STUDY AND EIR

PREPARED BY DUDEK. PROVIDE 6' HIGH PLEX-GLASS BARRIER AT BALCONIES AT 3rd AND 4th LEVELS AT BUILDING NUMBERS 11, 12, 21 & 29, FROM SR-125 NOISE AND BUILDING NUMBERS
16 - 19 FROM BRT NOISE PER REPORT.



DEVELOPMENT IN DIEGO, CA 92121 HERITAGE BUILDING
4350 EXECUTIVE DRIVE SUITE 305



Revisions:

PLAN CHECK# CHULA VISTA BR16-0014 THROUGH 0017

Sheet Title: BLDG TYPE 100 FOURTH FLOOR PLAN



RIGHT ELEVATION

**EXTERIOR NOTES** 

SEE GENERAL NOTES FOR TYPICAL REQUIREMENTS.
FIRST FLOOR WINDOW HEAD HEIGHT: 8'-0" U.N.O.
SECOND FLOOR WINDOW HEAD HEIGHT: 8'-0" U.N.O.
THIRD FLOOR WINDOW HEAD HEIGHT: 8'-0" U.N.O.

1 EXTERIOR STUCCO PER GENERAL NOTES.

2 CONCRETE TILES, S-TILE PROFILE, SEE ROOF DETAILS.

3 FIRE BELL ALARM SIGNAL

4 WROUGHT IRON GUARD RAIL, SEE DETAIL #8/A950 2

5 DECORATIVE CORBELS, SEE DETAIL #14/A951 PROFILE 'F' 2

6 WOOD TRELLIS, SEE DETAIL #16/A952 A

7 STEEL CANOPY, SEE DETAIL #2/A952

8 HORIZONTAL STUCCO TRIM OVER HIGH DENSITY FOAM, SEE DETAIL 4/95

9 DECORATIVE LIGHT FIXTURE

10 OPT. DOOR AT ACCESSIBLE UNITS

11 STUCCO CONTROL JOINT

12 GAS METER LOCATION

ENTRY DOOR(S): THERMATRU FIBERGLASS AS SELECTED BY DEVELOPER.

14 EXTERIOR STROBE PER CVFD DETAIL, MOUNTED 14'-0" ABOVE FINISH GRADE, WEATHERPROOF PER NEMA 4X

15 MULTI-FAMILY RESIDENTIAL KNOX BOX PER CVFD DETAIL

BUILDING ADDRESS, SEE DETAIL 19/A951 FOR MORE INFO.

CONTRACTOR TO INSTALL PLEXIGLAS AT BALCONIES ON LEVELS 3 AND
4, AS DETERMINED BY NOISE CONTROL REQUIREMENTS.

- REFER TO REPORT PA-12 FC-2B, ADDENDUM TO PRIOR NOISE STUDY AND EIR PREPARED BY DUDEK.

- PROVIDE 6' HIGH PLEX-GLASS BARRIER AT BALCONIES AT 3rd AND 4th LEVELS AT BUILDING NUMBERS 11, 12, 21 & 29, FROM SR-125 NOISE AND BUILDING NUMBERS 16 - 19 FROM BRT NOISE PER REPORT.

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HERITAGE BUILDING & DEVELOPMENT 4350 EXECUTIVE DRIVE SUITE 305 SAN DIEGO, CA 92121



Revisions

07/14/201 REVISION

PLAN CHECK#

Sheet Title:
BLDG TYPE 100
EXTERIOR
ELEVATIONS

Job No. 15005

Date: 09/18/15

Scale: 1/8" = 1'-0

Drawn By:

Sheet No:

CONTRACTOR TO INSTALL PLEXIGLAS AT BALCONIES ON LEVELS 3 AND 4, AS DETERMINED BY NOISE CONTROL REQUIREMENTS.

- REFER TO REPORT PA-12 FC-2B, ADDENDUM TO PRIOR NOISE

PROVIDE 6' HIGH PLEX-GLASS BARRIER AT BALCONIES AT 3rd AND 4th LEVELS AT BUILDING NUMBERS 11, 12, 21 & 29, FROM SR-125 NOISE AND BUILDING NUMBERS 16 - 19 FROM BRT NOISE

STUDY AND EIR PREPARED BY DUDEK.

PER REPORT.


Sheet Title:
BLDG TYPE 100
BUILDING
SECTIONS

PLAN CHECK#


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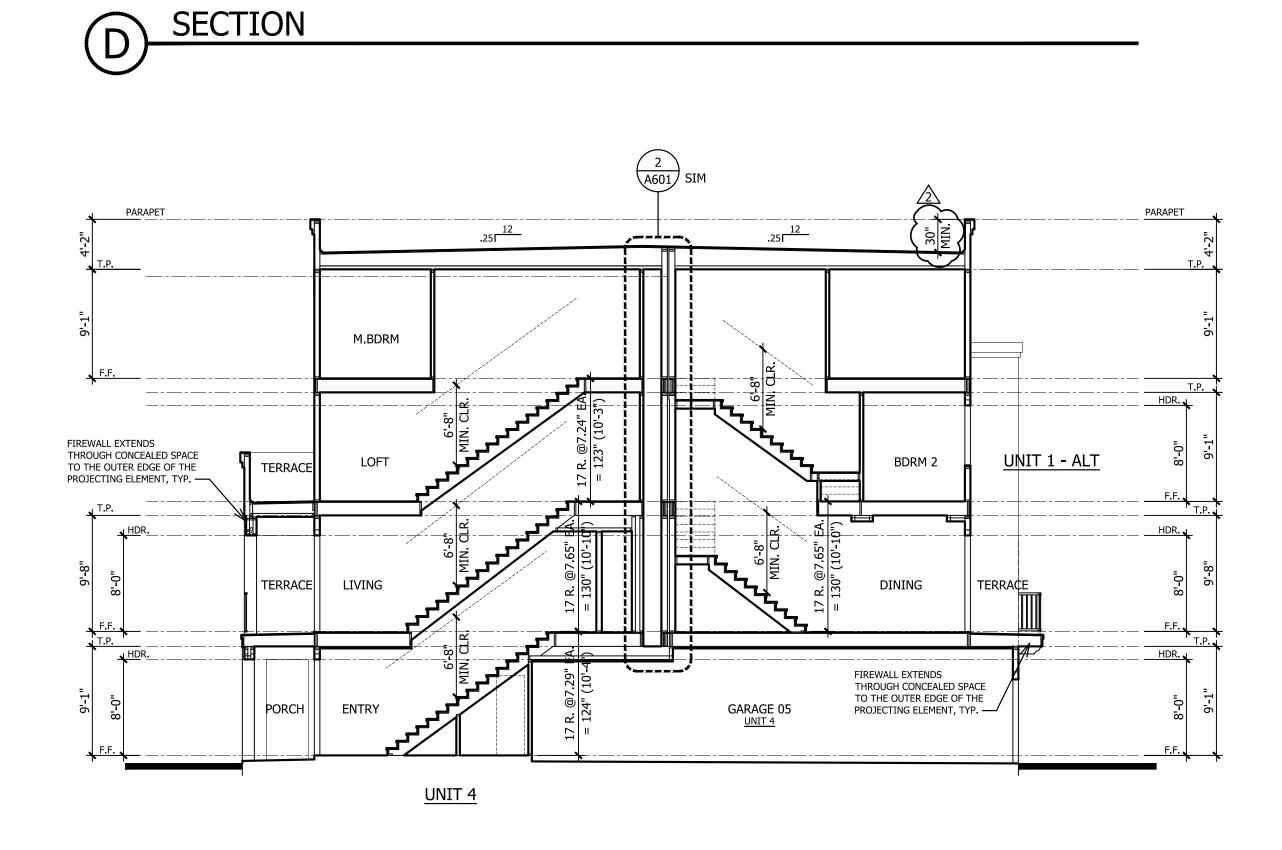
A170



(E) SECTION

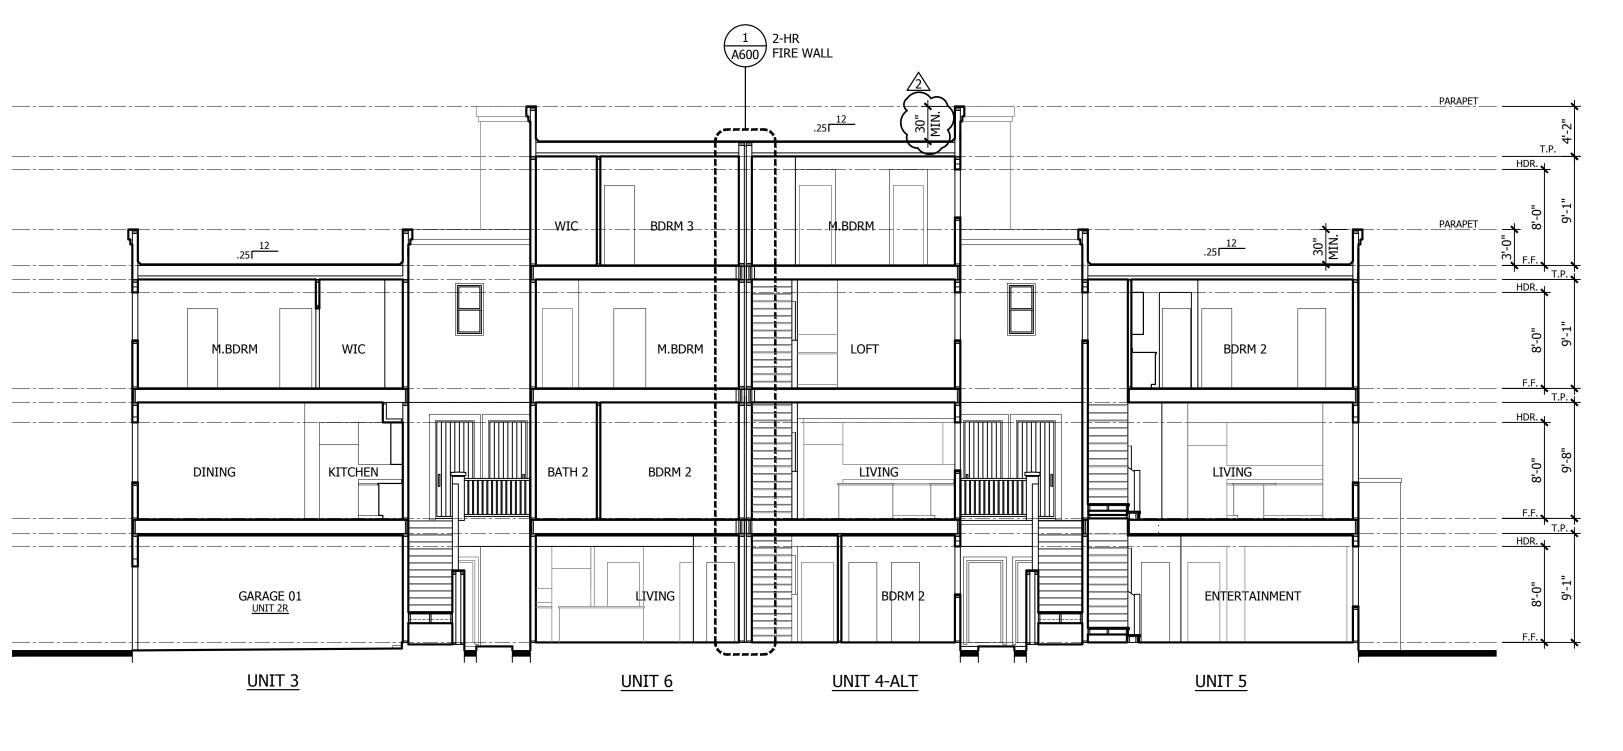

SECTION

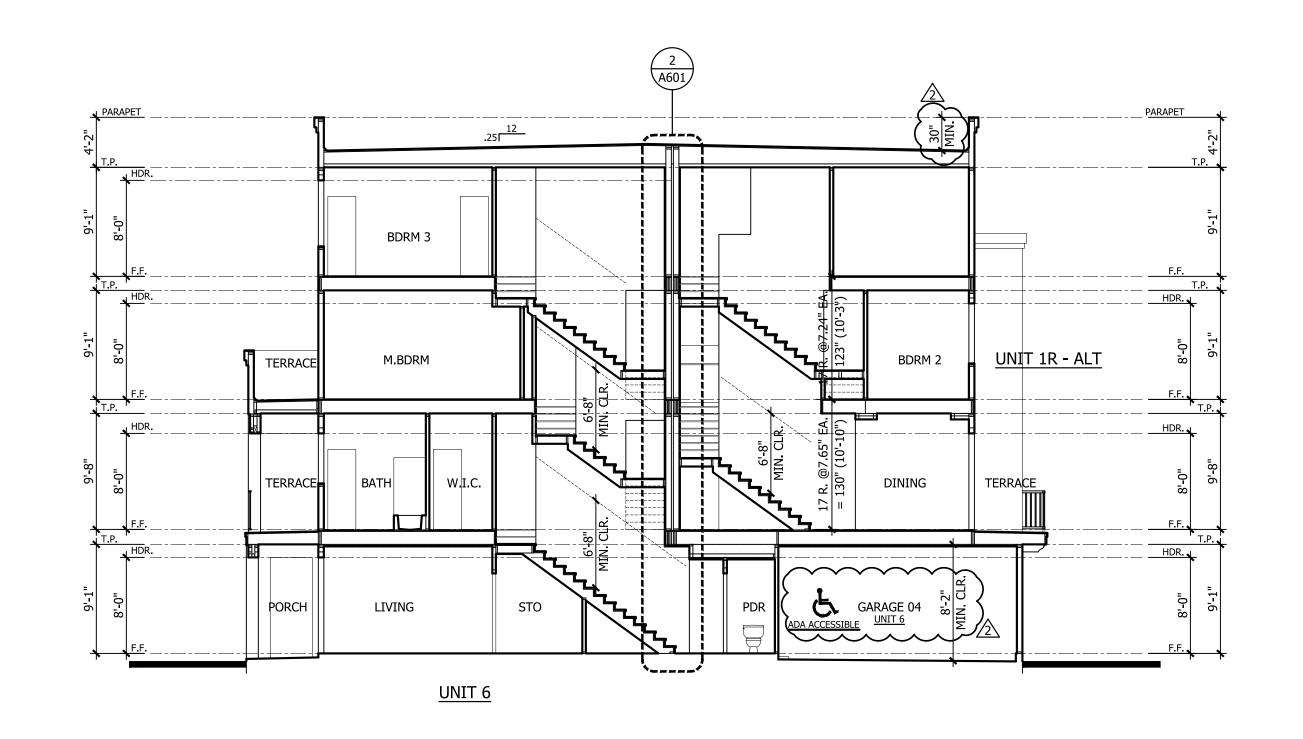

GARAGE 02 UNIT 1R - ALT GARAGE 03 UNIT 3

GARAGE 01 UNIT 2R

A SECTION

B SECTION

WIL MASAIH

BURM 2

BURM 2

BURM 2

F.E. T.P.

HOR.

HOR.

HOR.

WIL MASAIH

HOR.

HOR.

HOR.

WIL MASAIH


HOR.

WIL MASAIH

HOR.

WINIT 5

UNIT 2

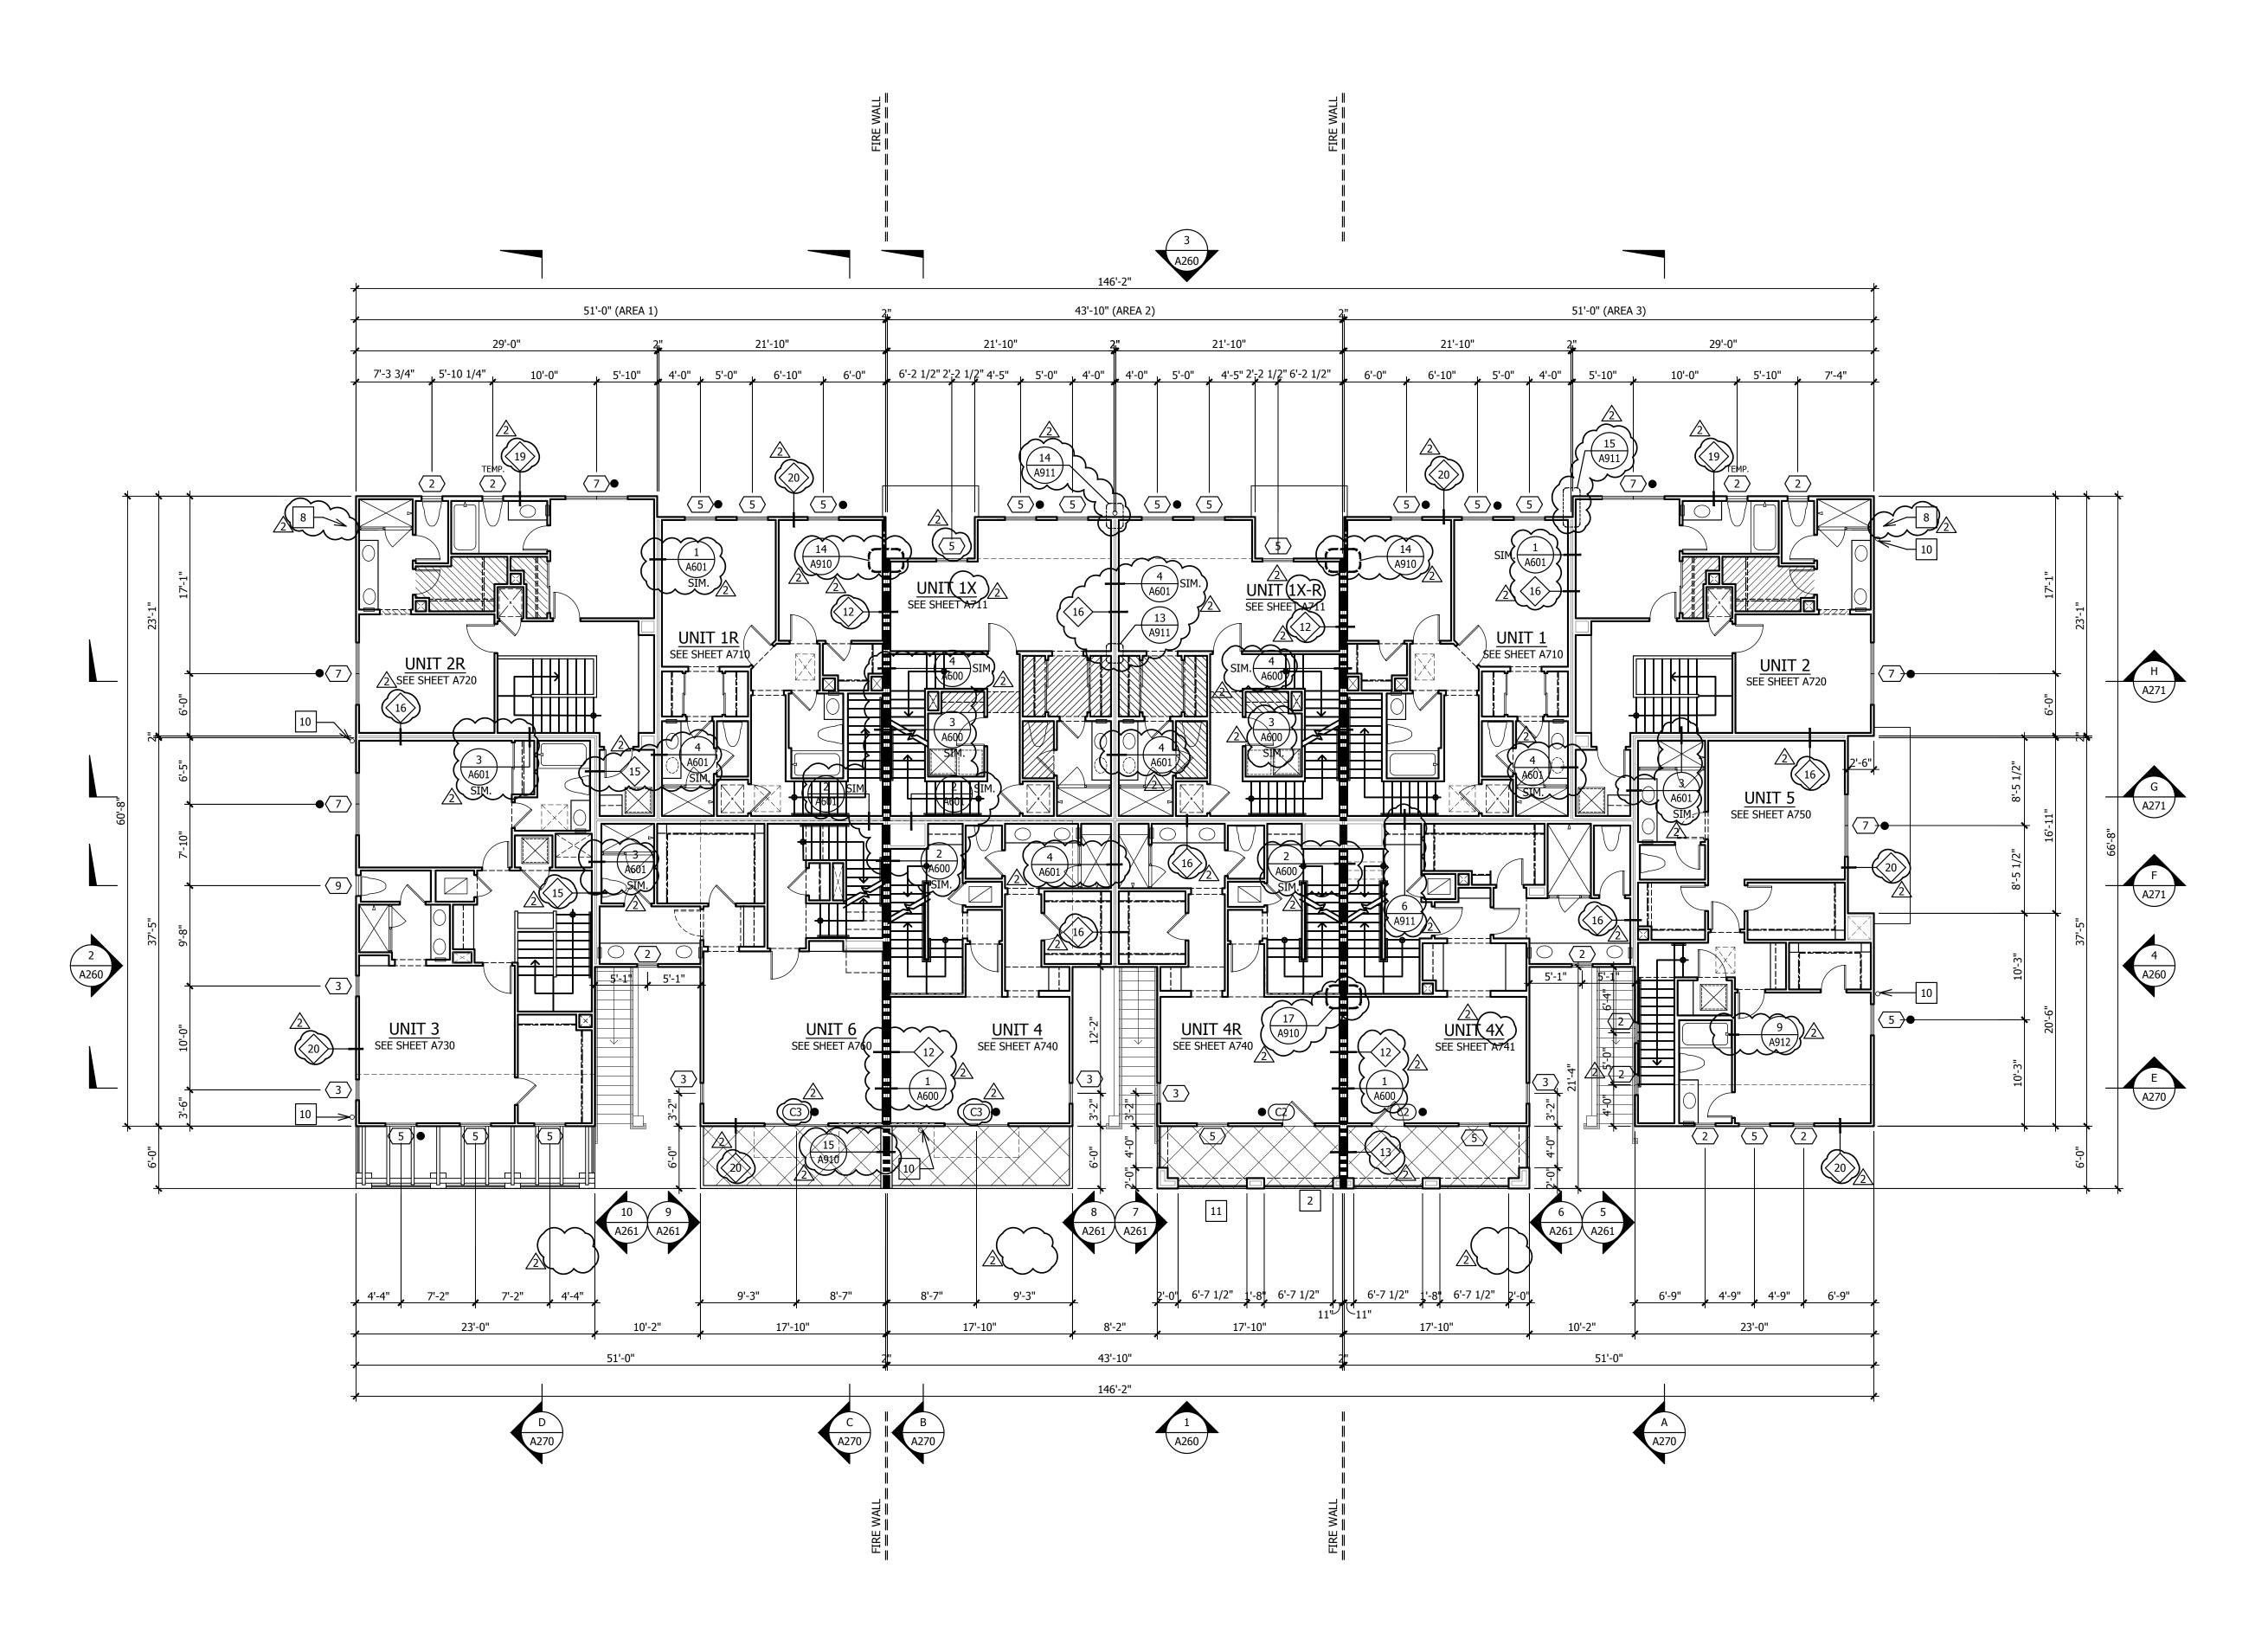

THIRD FLOOR PLAN

### PLAN NOTES

SEE GENERAL NOTES, SHEET GN, FOR TYPICAL REQUIREMENTS. REFER TO 1/4" UNIT PLANS FOR TYPICAL NOTES, DIMENSIONS, REFERENCES AND INTERIOR WALL ASSEMBLY TYPES. SEE DRAWINGS BY OTHERS FOR ELECTRICAL, PLUMBING AND HVAC. ALL DIAGONAL WALLS TO BE 45, UNLESS NOTED OTHERWISE. ALL EXTERIOR WALLS TO BE 2X6, U.N.O. SEE DETAIL 12/A960 FOR TYPICAL INTERIOR DOOR HEAD AND JAMB. FIRST FLOOR WINDOW HEAD HEIGHT: 8'-0" U.N.O. SECOND FLOOR WINDOW HEAD HEIGHT: 8'-0" U.N.O. THIRD FLOOR WINDOW HEAD HEIGHT: 8'-0" U.N.O.

1 LINE OF FLOOR OR ROOF ABOVE.

2 LINE OF WALL OR FLOOR BELOW.

3 LOW WALL, STUCCO CAP, ROUGH HEIGHT AS NOTED, SEE DETAIL #15/A951

5 GUARDRAIL, WROUGHT IRON, SEE DETAIL #8/AD213.

6 TANKLESS WATER HEATER.

7 TRASH/RECYCLE BINS.

8 ROOF ACCESS LADDER (SHIP LADDER STYLE)

DOWNSPOUT LOCATION, CONNECT TO STORM DRAIN, SEE DETAILS 14/A920, 22/A920 & PLUMBING PLANS

DOWNSPOUT LOCATION, EXPEL ON ROOF BELOW, SEE DETAIL #24/AD501 & PLUMBING PLANS

PRIVATE PATIO / TERRACE (DENOTED BY CROSSHATCH).

EXTERIOR STROBE PER CVFD DETAIL, MOUNTED 14'-0" ABOVE FINISH GRADE, WEATHERPROOF PER NEMA 4X

14 MULTI-FAMILY RESIDENTIAL KNOX BOX PER CVFD DETAIL

#### **LEGEND**

# SEE WINDOW SCHEDULE, SHEET A800

# ■ ADJACENT DOT DENOTES EGRESS WINDOW

# ADJACENT STAR DENOTES ROOFTOP MECHANICAL ACCESS WINDOW (22"x24" MIN CLEAR OPENING)

# SEE DOOR SCHEDULE, SHEET A800

# • ADJACENT DOT DENOTES EGRESS DOOR

# SEE WALL TYPE SCHEDULE, SHEET A810

TYPICAL ONE HOUR WALL CONSTRUCTION,

UNPROTECTED OPENING ALLOWED

TYPICAL ONE HOUR FIRE PARTITION, PROTECTED

TYPICAL ONE HOUR DWELLING UNIT SEPARATION, PARTY WALL CONSTRUCTION, DOUBLE STUD WALL

TWO HOUR FIRE WALL CONSTRUCTION, DOUBLE STUD WALL

PENETRATIONS OF FIRE WALLS SHALL BE PROTECTED WITH
THROUGH-PENETRATION FIRE STOPS AND MEMBRANE-PENETRATION FIRE
STOPS IN ACCORDANCE WITH CBC SECTION 714.

FEC SEMI-RECESSED FIRE EXTINGUISHER CABINET, SEE 16/A912

CONTRACTOR TO INSTALL PLEXIGLAS AT BALCONIES ON LEVELS 3 AND 4, AS DETERMINED BY NOISE CONTROL REQUIREMENTS.

- REFER TO REPORT PA-12 FC-2B ADDENDUM TO PRIOR NOISE STUDY AND FIR

REFER TO REPORT PA-12 FC-2B, ADDENDUM TO PRIOR NOISE STUDY AND EIR PREPARED BY DUDEK.
 PROVIDE 6' HIGH PLEX-GLASS BARRIER AT BALCONIES AT 3rd AND 4th LEVELS AT BUILDING NUMBERS 11, 12, 21 & 29, FROM SR-125 NOISE AND BUILDING NUMBERS 16 - 19 FROM BRT NOISE PER REPORT.



HERITAGE BUILDING & DEVELOPMENT 4350 EXECUTIVE DRIVE SUITE 305 SAN DIEGO, CA 92121

Revisions:


07/14/201 REVISION

PLAN CHECK# CHULA VISTA BR16-0014 THROUGH 0017

Sheet Title:
BLDG TYPE 200
THIRD FLOOR PLAN

ob No. 15005 Date: 09/18/15 Scale: 1/8" = 1'-0

Sheet No:

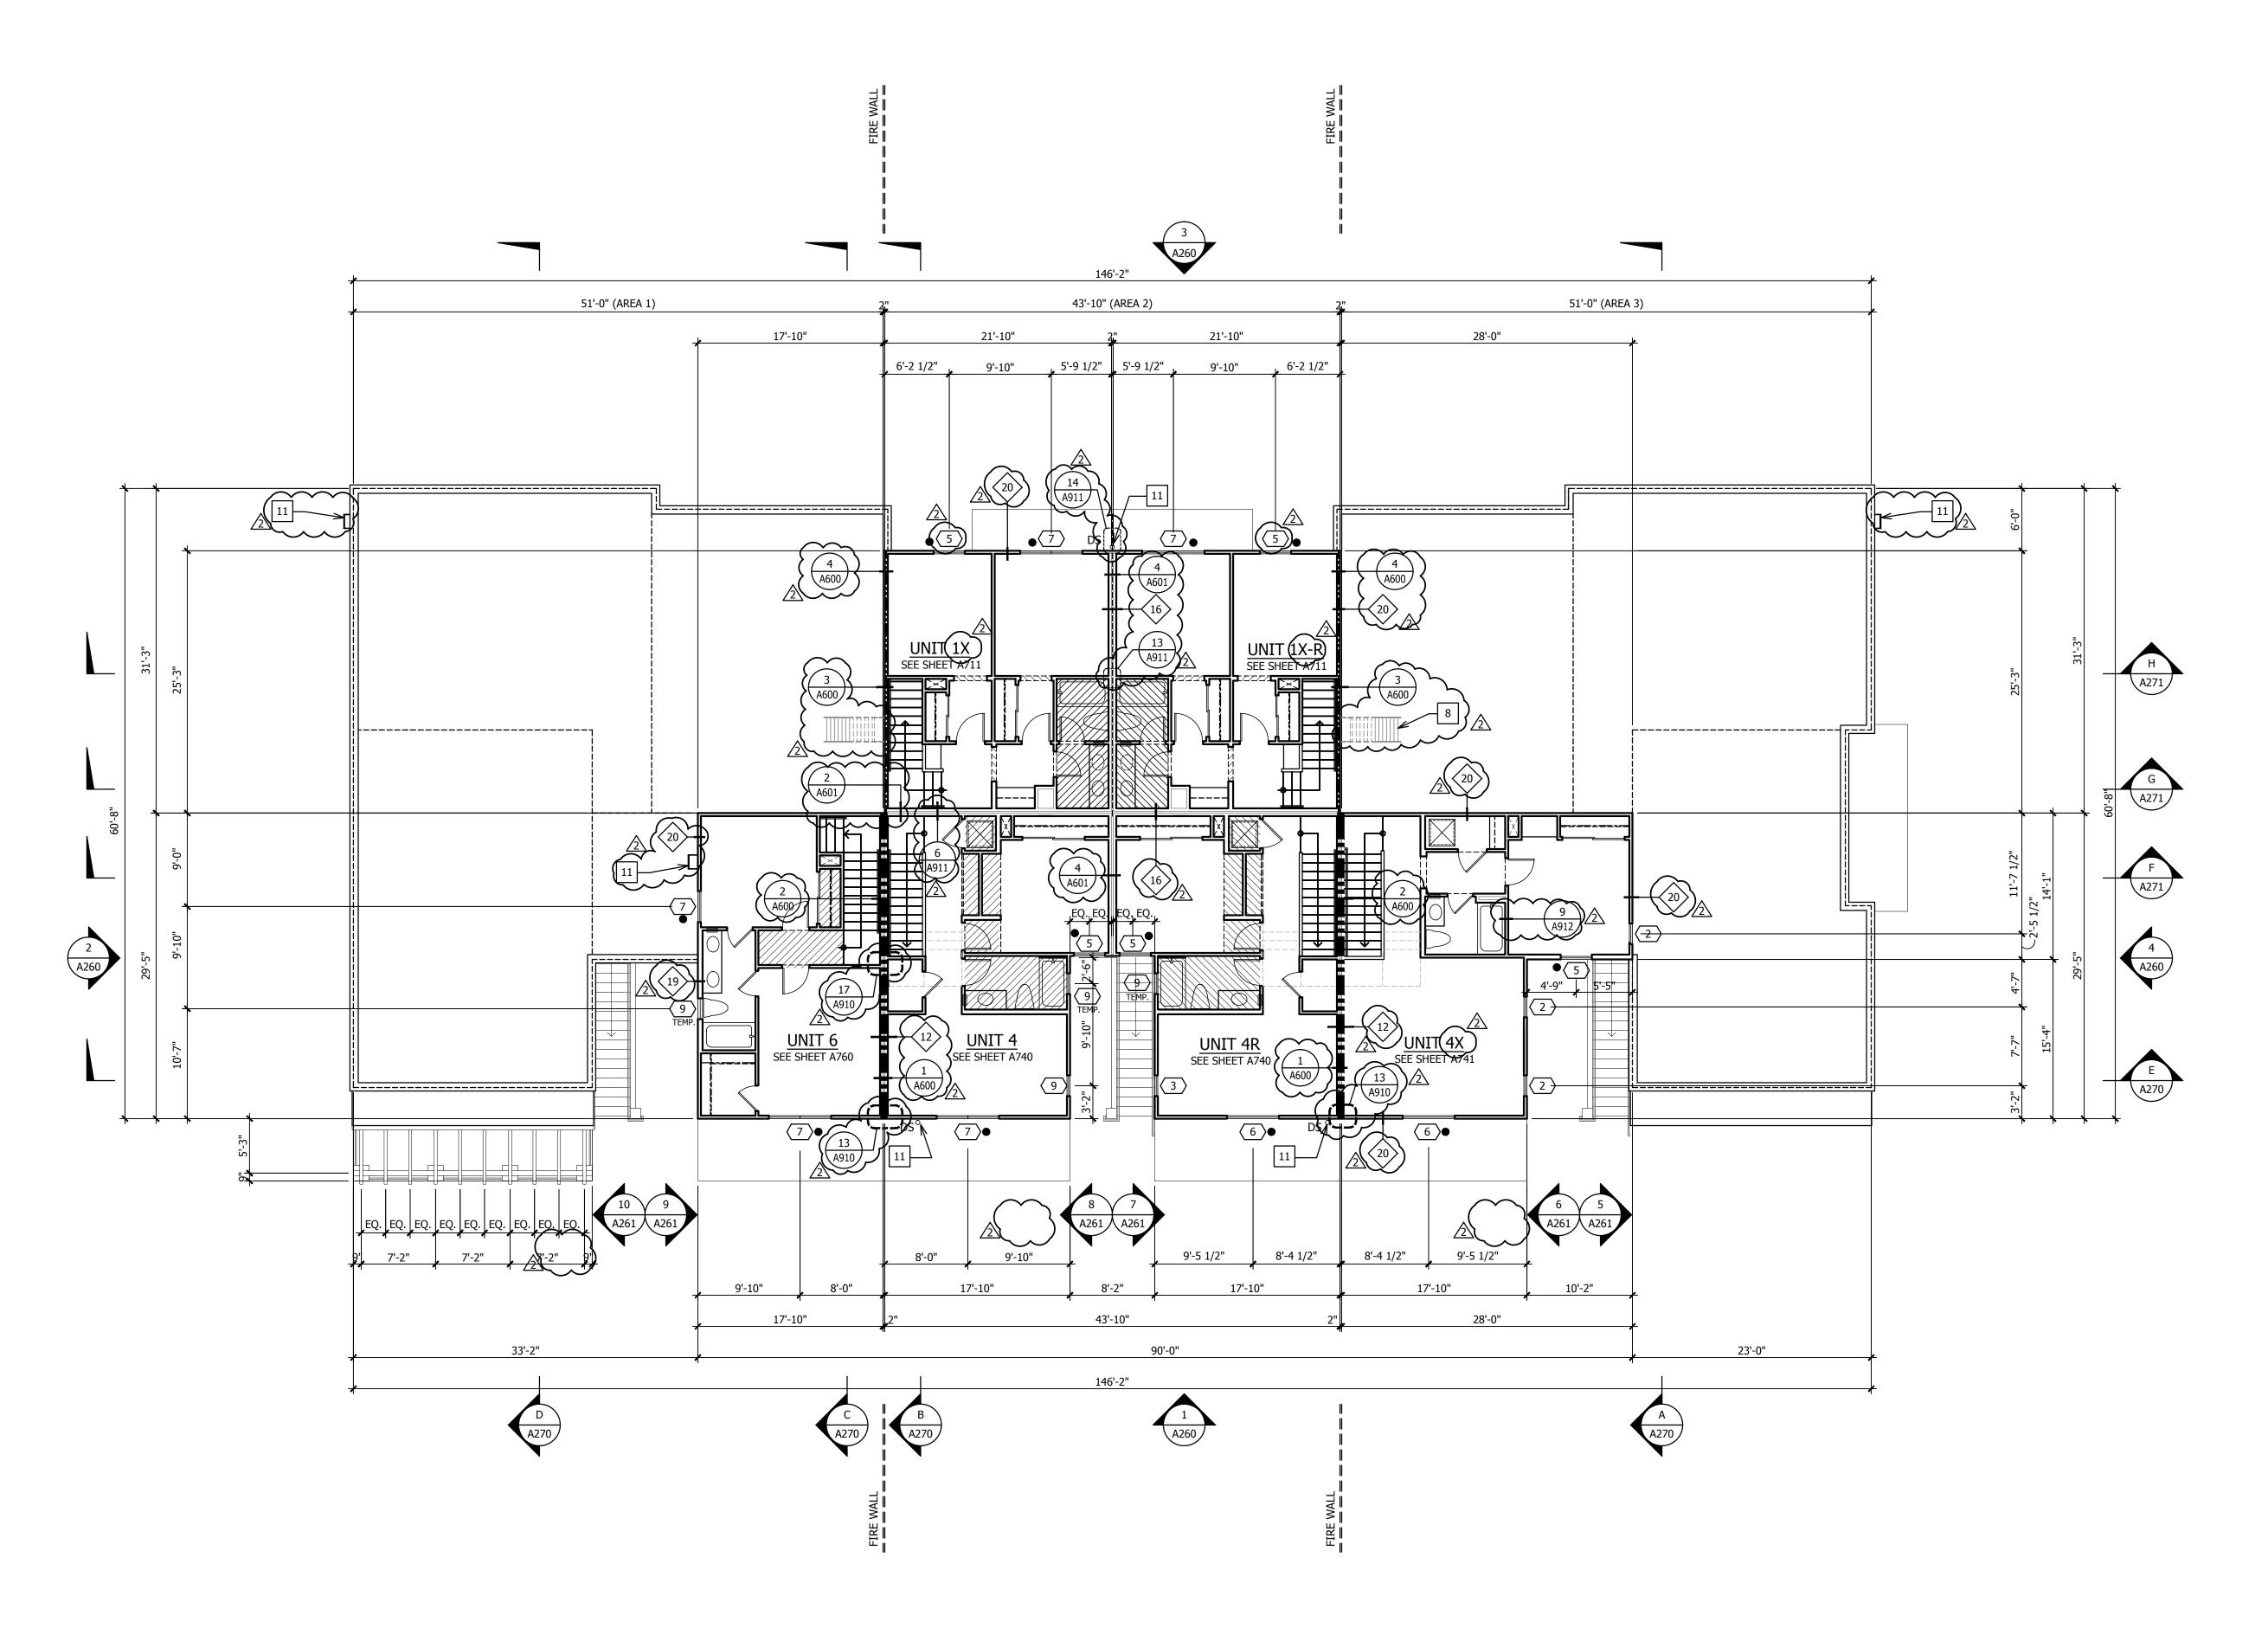

FOURTH FLOOR PLAN

### **PLAN NOTES**

SEE GENERAL NOTES, SHEET GN, FOR TYPICAL REQUIREMENTS. REFER TO 1/4" UNIT PLANS FOR TYPICAL NOTES, DIMENSIONS, REFERENCES AND INTERIOR WALL ASSEMBLY TYPES. SEE DRAWINGS BY OTHERS FOR ELECTRICAL, PLUMBING AND HVAC. ALL DIAGONAL WALLS TO BE 45, UNLESS NOTED OTHERWISE. ALL EXTERIOR WALLS TO BE 2X6, U.N.O. SEE DETAIL 12/A960 FOR TYPICAL INTERIOR DOOR HEAD AND JAMB. FIRST FLOOR WINDOW HEAD HEIGHT: 8'-0" U.N.O. SECOND FLOOR WINDOW HEAD HEIGHT: 8'-0" U.N.O. THIRD FLOOR WINDOW HEAD HEIGHT: 8'-0" U.N.O.

1 LINE OF FLOOR OR ROOF ABOVE.

2 LINE OF WALL OR FLOOR BELOW.

3 LOW WALL, STUCCO CAP, ROUGH HEIGHT AS NOTED, SEE DETAIL #15/A951 4 FIRE BELL ALARM SIGNAL

5 GUARDRAIL, WROUGHT IRON, SEE DETAIL #8/AD213.

6 TANKLESS WATER HEATER.

7 TRASH/RECYCLE BINS. 

8 ROOF ACCESS LADDER (SHIP LADDER STYLE)
9 NOT USED

DOWNSPOUT LOCATION, CONNECT TO STORM DRAIN, SEE DETAILS 14/A920, 22/A920 & PLUMBING PLANS

DOWNSPOUT LOCATION, EXPEL ON ROOF BELOW, SEE DETAIL #24/AD501 & PLUMBING PLANS 12 PRIVATE PATIO / TERRACE (DENOTED BY CROSSHATCH). EXTERIOR STROBE PER CVFD DETAIL, MOUNTED 14'-0" ABOVE

FINISH GRADE, WEATHERPROOF PER NEMA 4X MULTI-FAMILY RESIDENTIAL KNOX BOX PER CVFD DETAIL

### **LEGEND**

# SEE WINDOW SCHEDULE, SHEET A800

# ◆ ADJACENT DOT DENOTES EGRESS WINDOW

# ADJACENT STAR DENOTES ROOFTOP MECHANICAL ACCESS WINDOW (22"x24" MIN CLEAR OPENING)

# SEE DOOR SCHEDULE, SHEET A800

# • ADJACENT DOT DENOTES EGRESS DOOR # SEE WALL TYPE SCHEDULE, SHEET A810

TYPICAL ONE HOUR WALL CONSTRUCTION, UNPROTECTED OPENING ALLOWED

TYPICAL ONE HOUR FIRE PARTITION, PROTECTED OPENINGS REQUIRED

TYPICAL ONE HOUR DWELLING UNIT SEPARATION, PARTY WALL CONSTRUCTION, DOUBLE STUD WALL

TWO HOUR FIRE WALL CONSTRUCTION, DOUBLE STUD WALL PENETRATIONS OF FIRE WALLS SHALL BE PROTECTED WITH THROUGH-PENETRATION FIRE STOPS AND MEMBRANE-PENETRATION FIRE STOPS IN ACCORDANCE WITH CBC SECTION 714.

FEC SEMI-RECESSED FIRE EXTINGUISHER CABINET, SEE 16/A912

CONTRACTOR TO INSTALL PLEXIGLAS AT BALCONIES ON LEVELS 3 AND 4, AS DETERMINED BY NOISE CONTROL REQUIREMENTS. REFER TO REPORT PA-12 FC-2B, ADDENDUM TO PRIOR NOISE STUDY AND EIR

PROVIDE 6' HIGH PLEX-GLASS BARRIER AT BALCONIES AT 3rd AND 4th LEVELS AT BUILDING NUMBERS 11, 12, 21 & 29, FROM SR-125 NOISE AND BUILDING NUMBERS 16 - 19 FROM BRT NOISE PER REPORT.

DEVELOPMENT
IN DIEGO, CA 92121

Revisions:

07/14/2016 REVISIONS

PLAN CHECK# CHULA VISTA BR16-0014 THROUGH 0017

Sheet Title: BLDG TYPE 200 FOURTH FLOOR PLAN

Drawn By:

## **EXTERIOR NOTES**

SEE GENERAL NOTES FOR TYPICAL REQUIREMENTS. FIRST FLOOR WINDOW HEAD HEIGHT: 8'-0" U.N.O. SECOND FLOOR WINDOW HEAD HEIGHT: 8'-0" U.N.O. THIRD FLOOR WINDOW HEAD HEIGHT: 8'-0" U.N.O.

1 EXTERIOR STUCCO PER GENERAL NOTES. 2 CONCRETE TILES, S-TILE PROFILE, SEE ROOF DETAILS. 3 FIRE BELL ALARM SIGNAL  $\overline{ }$ 

4 WROUGHT IRON GUARD RAIL, SEE DETAIL (#8/A950) 5 DECORATIVE CORBELS, SEE DETAIL #14/A951 PROFILE 'F' 2 WOOD TRELLIS, SEE DETAIL #16/A952

STEEL CANOPY, SEE DETAIL #2/A952 8 HORIZONTAL STUCCO TRIM OVER HIGH DENSITY FOAM, SEE DETAIL 4/9 9 DECORATIVE LIGHT FIXTURE

10 OPT. DOOR AT ACCESSIBLE UNITS 11 STUCCO CONTROL JOINT

12 GAS METER LOCATION ENTRY DOOR(S): THERMATRU FIBERGLASS AS SELECTED BY 14 EXTERIOR STROBE PER CVFD DETAIL, MOUNTED 14'-0" ABOVE FINISH GRADE, WEATHERPROOF PER NEMA 4X 15 MULTI-FAMILY RESIDENTIAL KNOX BOX PER CVFD DETAIL

16 BUILDING ADDRESS, SEE DETAIL 19/A951 FOR MORE INFO.

CONTRACTOR TO INSTALL PLEXIGLAS AT BALCONIES ON LEVELS 3 AND 4, AS DETERMINED BY NOISE CONTROL REQUIREMENTS. REFER TO REPORT PA-12 FC-2B, ADDENDUM TO PRIOR NOISE STUDY AND EIR PREPARED BY DUDEK. PROVIDE 6' HIGH PLEX-GLASS BARRIER AT BALCONIES AT 3rd AND 4th LEVELS AT BUILDING NUMBERS 11, 12, 21 & 29, FROM SR-125 NOISE AND BUILDING NUMBERS 16 - 19 FROM BRT NOISE PER REPORT. 

DEVELOPMENT IN DIEGO, CA 92121

Revisions:

07/14/2016 REVISIONS

PLAN CHECK# CHULA VISTA BR16-0014 THROUGH 0017

Sheet Title: BLDG TYPE 200 EXTERIOR ELEVATIONS


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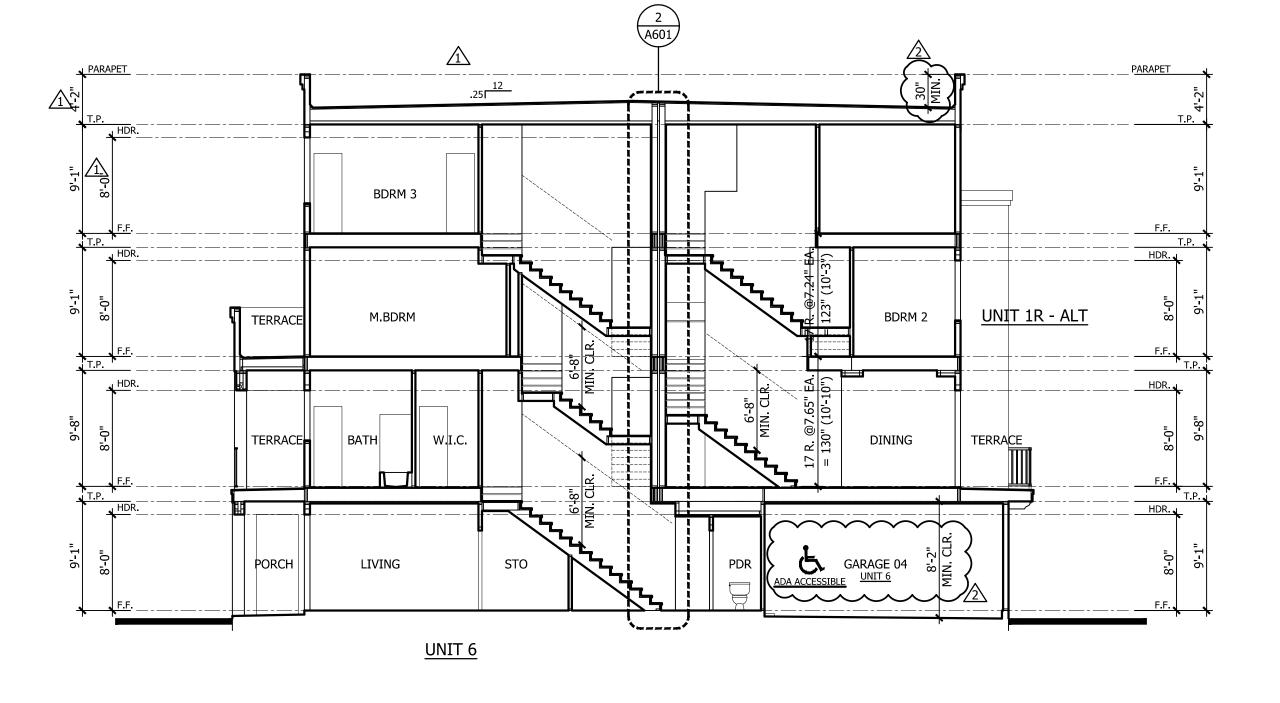
Date: 09/18/1!

Scale: 1/8" = 1

Drawn By: 1/8" = 1'-0"

CONTRACTOR TO INSTALL PLEXIGLAS AT BALCONIES ON LEVELS 3 AND 4, AS DETERMINED BY NOISE CONTROL REQUIREMENTS. REFER TO REPORT PA-12 FC-2B, ADDENDUM TO PRIOR NOISE STUDY AND EIR PREPARED BY DUDEK. PROVIDE 6' HIGH PLEX-GLASS BARRIER AT BALCONIES AT 3rd AND 4th LEVELS AT BUILDING NUMBERS 11, 12, 21 & 29, FROM SR-125 NOISE AND BUILDING NUMBERS 16 - 19 FROM BRT NOISE PER REPORT. 




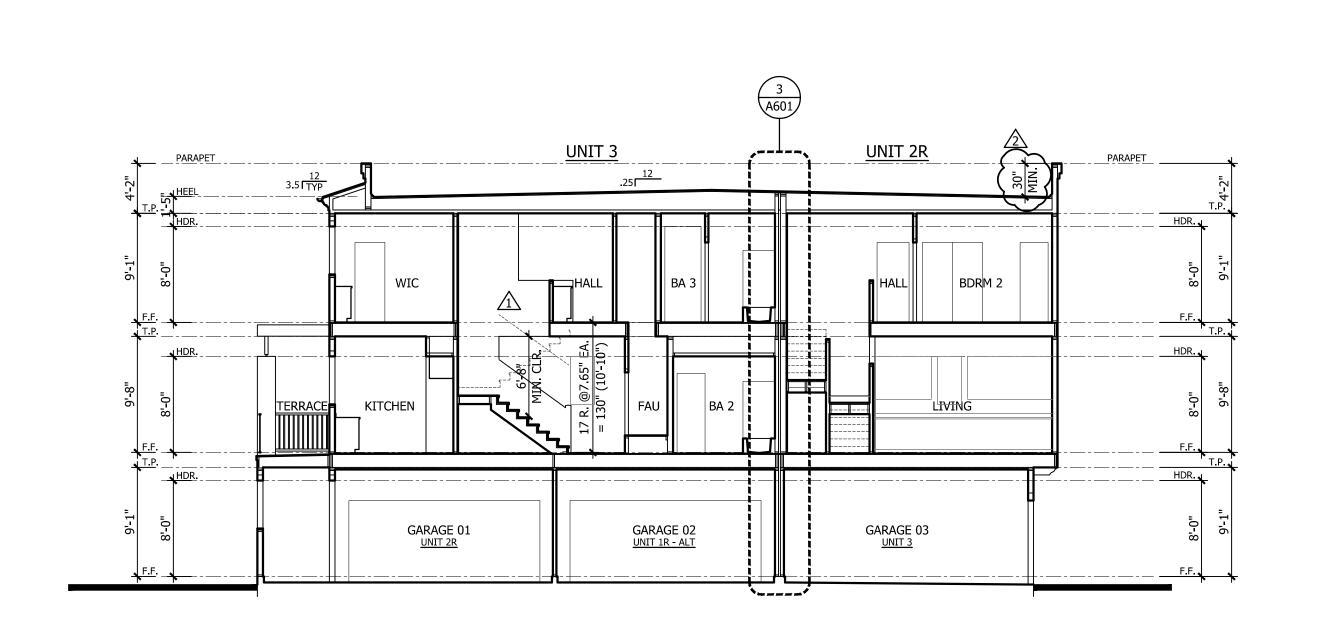




B SECTION



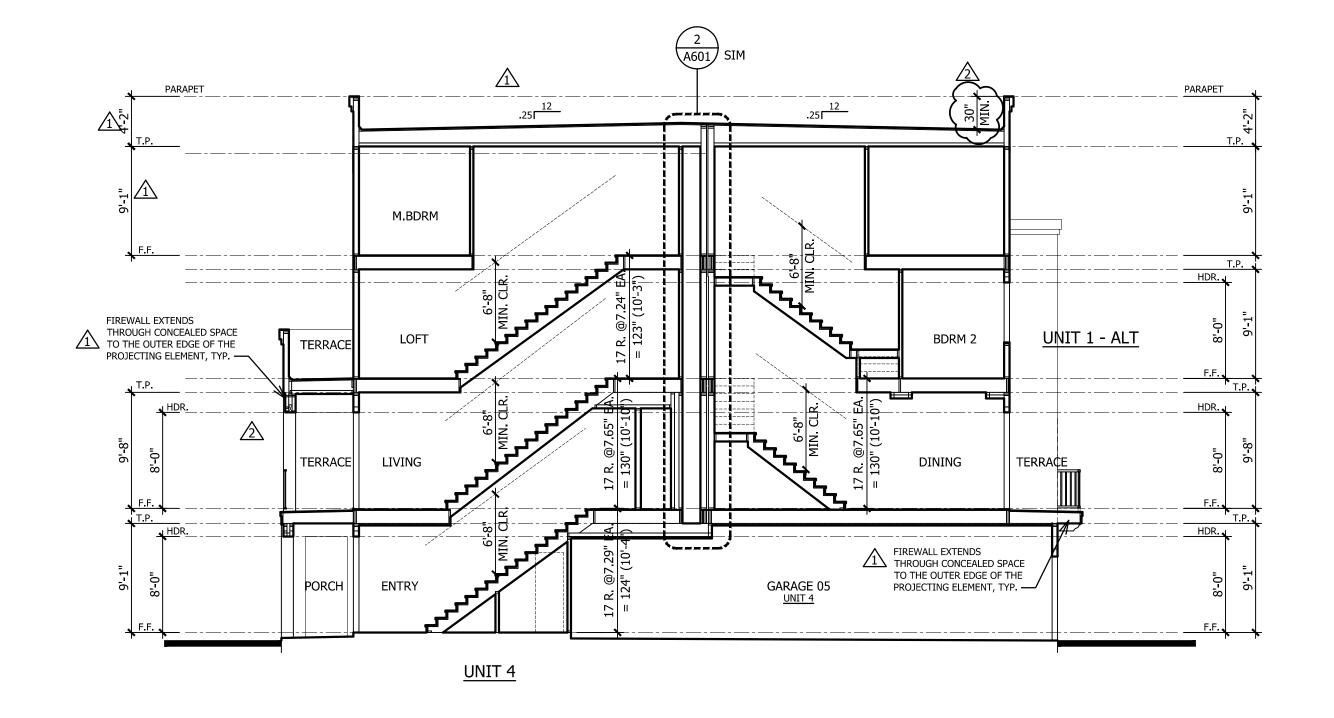

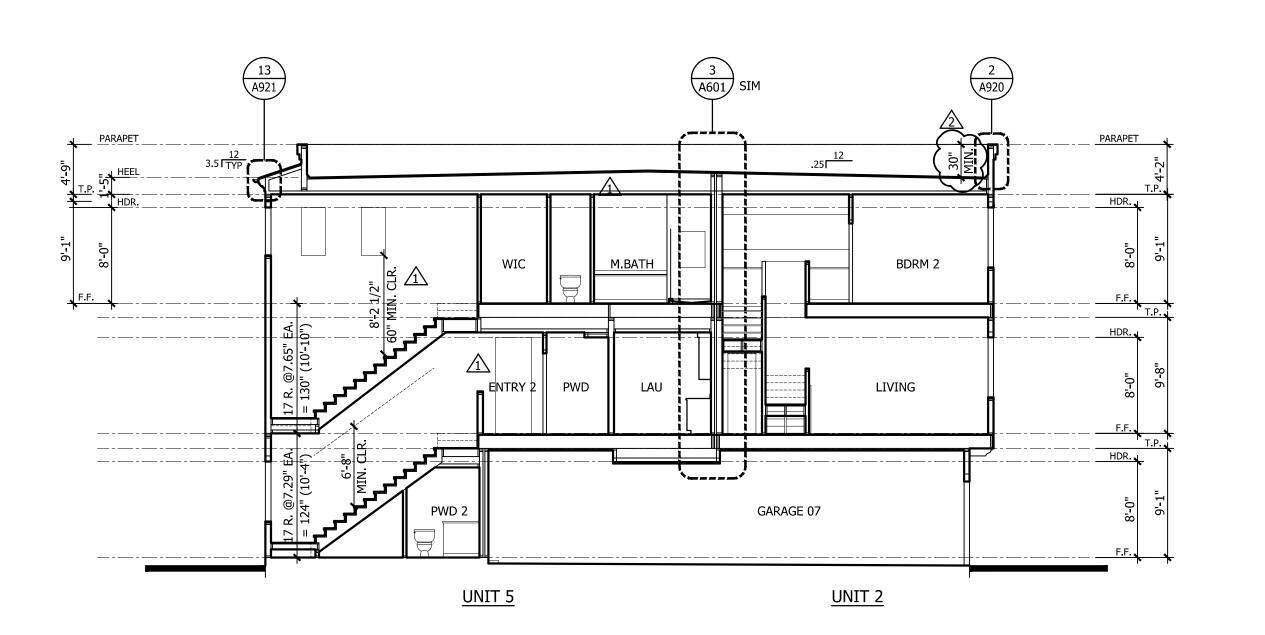

A SECTION

PLAN CHECK# CHULA VISTA BR16-0014 THROUGH 0017


Revisions:

07/14/2016 REVISIONS


Sheet Title: BLDG TYPE 200 BUILDING SECTIONS

Drawn By:


## THIRD FLOOR INTERIOR ELEVATIONS

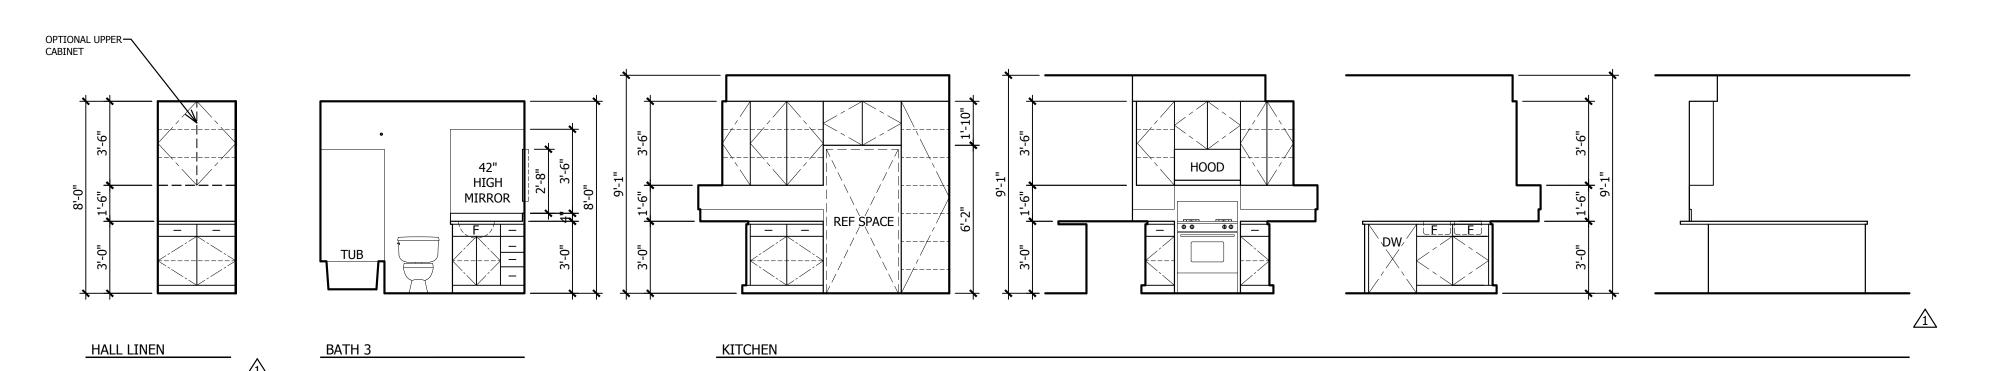

## SECOND FLOOR INTERIOR ELEVATIONS

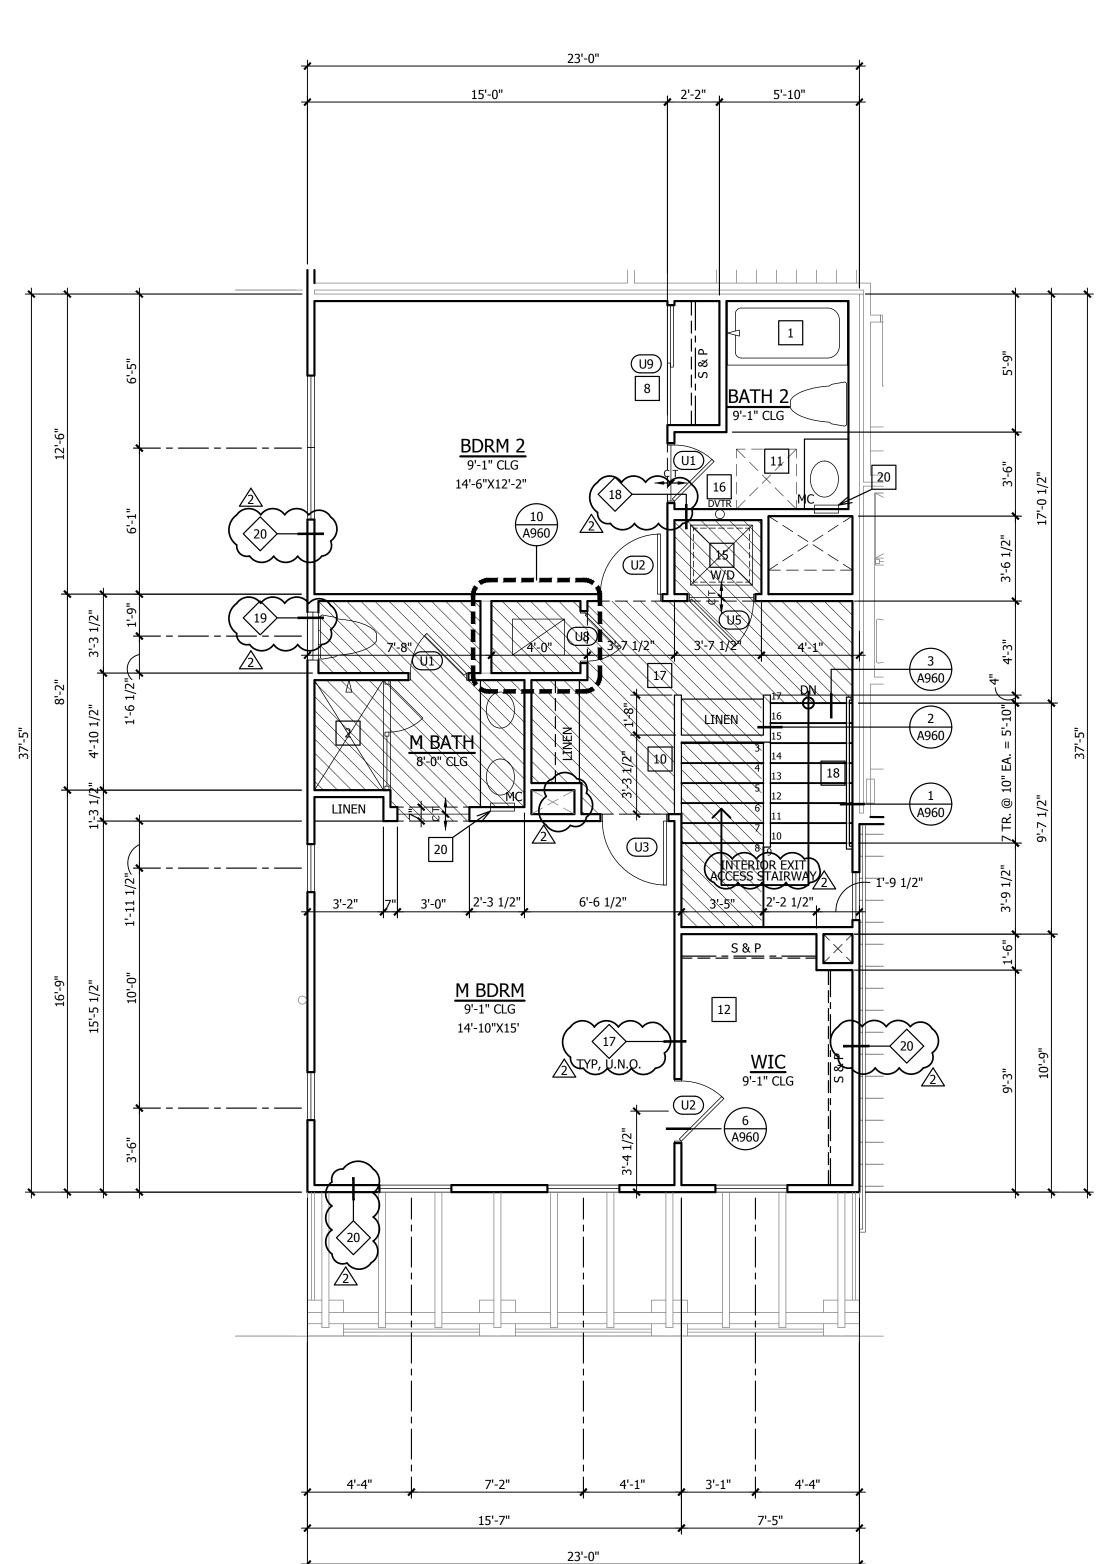

THIRD FLOOR SECOND FLOOR (UNIT ABOVE GARAGE)

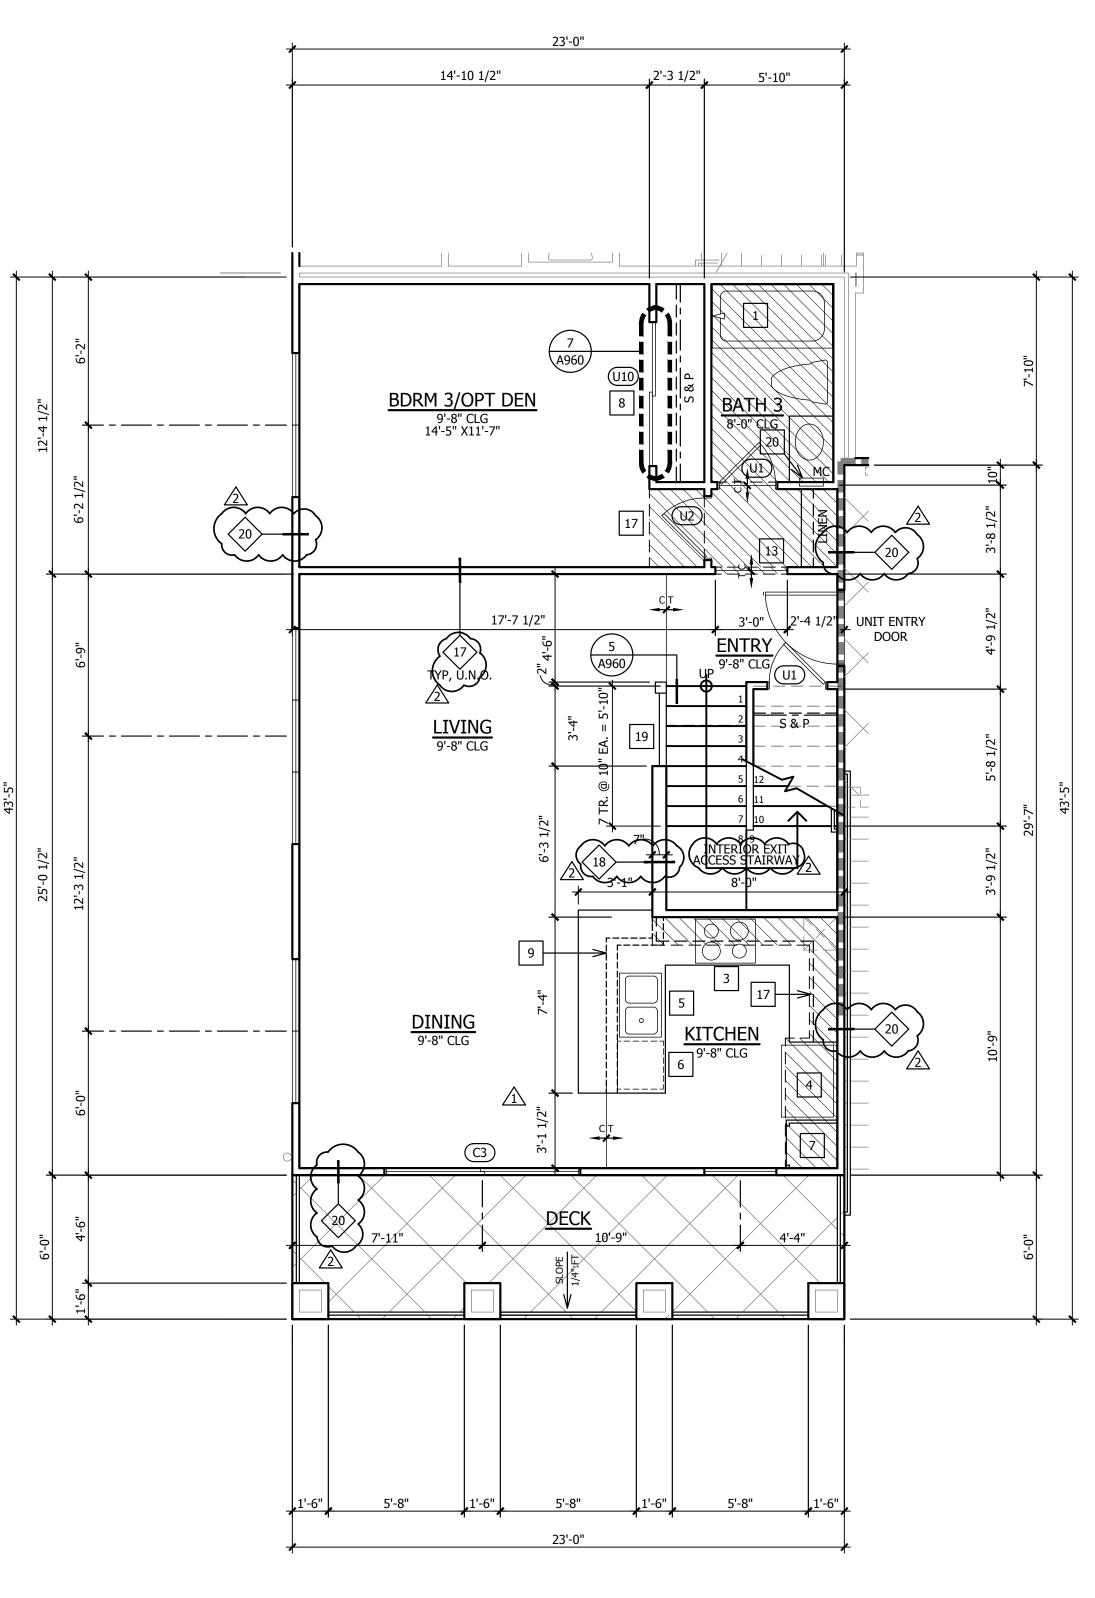

## UNIT PLAN GENERAL NOTES

- 1. REFER GENERAL NOTES SHEETS FOR TYPICAL REQUIREMENTS 2. EXTERIOR DOOR AND WINDOW TYPES AND LOCATIONS ARE
- SHOWN ON THE BUILDING FLOOR PLANS. 3. ALL DIAGONAL WALLS TO BE 45°, UNLESS NOTED OTHERWISE
- 4. ALL DIMENSIONS NOTED ON THIS PLAN ARE TO FACE OF STUD UNLESS NOTED OTHERWISE
- 5. FOR EXTERIOR WALL ASSEMBLY TYPES, DOORS AND WINDOW LOCATIONS, REFER TO BUILDING PLANS.
- 6. ALL PLUMBING WALLS SHALL BE 2X6 STUDS, UNLESS NOTED OTHERWISE
- 7. INTERIOR PARTITIONS SHALL BE 2X4 STUDS, UNLESS NOTED OTHERWISE 8. SMOKE DETECTORS MUST BE INSTALLED IN EACH SLEEPING
- ROOM AND IN A CENTRAL LOCATION TO PROTECT SLEEPING AREAS IN ACCORDANCE WITH APPROVED MANUFACTURER'S INSTRUCTIONS. SEE ELECTRICAL PLANS FOR LOCATIONS. 9. CARBON MONOXIDE DETECTORS MUST BE INSTALLED
- OUTSIDE OF EACH BEDROOM IN THE IMMEDIATE VICINITY OF THE BEDROOM AND ON EVERY LEVEL OF EACH DWELLING UNIT. SEE ELECTRICAL PLANS FOR LOCATIONS.
- 10. GRAB BAR REINFORCEMENT REQUIRED AT GROUND LEVEL OF ADAPTABLE UNITS ONLY. SEE ELEVS AND GENERAL NOTES. 11. REFER TO PLANS AND BUILDING SECTIONS FOR STAIR TREAD
- AND RISER INFORMATION. 12. PROVIDE 1-HR RATED ENCLOSURE UNDERNEATH STAIR.
- 13. ALL GLAZING AT SHOWER DOOR AND ENCLOSURE TO BE OF SAFETY GLAZING IN ACCORDANCE WITH CBC SECTION 2406.4
- GUARDRAIL INFORMATION. 15. CABINET INTERIOR ELEVATIONS AS SHOWN FOR DESIGN INTENT ONLY. THE FINAL CABINET DESIGN SHALL BE AS SHOWN ON THE CABINET SHOP DRAWINGS AS APPROVED BY

14. REFER TO DETAIL SHEET A960 FOR STAIR, HANDRAIL AND

16. PROVIDE BACKING AS REQUIRED FOR CABINETRY, TOILET ACCESSORIES & TOWEL BARS.

THE BUILDER.

- 17. SHOWER HEAD SHALL BE INSTALLED AT 84" A.F.F. 18. FOR TYPICAL INTERIOR DOOR HEAD AND JAMB SEE DETAIL
- 19. VERIFY THE EXACT FAU DIMENSIONS AND CLEARANCE
- REQUIREMENTS PRIOR TO BUILDING THE ENCLOSING WALLS. 20. VERIFY FRAME OPENING DIMENSIONS FOR TUBS AND SHOWERS AGAINST MANUFACTURERS CUT SHEETS AND
- ADJUST OPENINGS AS REQUIRED.

  21. IN ADDITION TO RECESSED FIRE EXTINGUISHERS AT UNIT & GARAGE ENTRIES, EACH UNIT IS TO BE PROVIDED A PORTABLE FIRE EXTINGUISHER HAVING A MIN. RATING OF 1-A: 10-B: C

#### UNIT PLAN KEY NOTES


- 1 FIBERGLASS TUB/SHOWER WITH INTEGRAL SURROUND. FIBERCARE MODEL #ET60-32L.
- 1.1 FIBERGLASS TUB/SHOWER WITH INTEGRAL SURROUND. ☐ FIBERCARE MODEL #ET60-32R.
- 2 FIBERGLASS SHOWER WITH INTEGRAL SURROUND. A. PLAN 1 - FIBERCARE MODEL #ES60-36WS B. PLAN 2 - FIBERCARE MODEL #ES60-36WS C. PLAN 3 - FIBERCARE MODEL #ES60-36WS
- D. PLAN 4 MB FIBERCARE MODEL #ES60-36WS BA2 - FIBERCARE MODEL #ES48-34 E. PLAN 5 - FIBERCARE MODEL #ES48-34 F. PLAN 6 - FIBERCARE MODEL #ES60-36WS
- 2.1 ACCESSIBLE ROLL-IN SHOWER, 44" X 48" HOT-MOPPED PAN WITH CERAMIC TILE SURROUND 70" ABOVE DRAIN. SEE
- 3 30" SLIDE-IN GAS RANGE/OVEN, 110V RECEPTACLE. 30" HOOD, LIGHT, EXHAUST FAN, 110V RECEPTACLE. VENT PER
- GENERAL NOTES DIVISION 15.2. 4 REFRIGERATOR, 39" WIDE X 72" HIGH CLEAR SPACE
- DOUBLE SINK WITH GARBAGE DISPOSAL
- 6 DISHWASHER UNDER COUNTERTOP
- PANTRY CABINET WITH SHELVES
- WARDROBE SLIDING DOORS, SIZE AS NOTED, SEE 7/A960. 9 2x6 LOW WALL BELOW COUNTER TOP.
- 10 LOW WALL WITH CAP, 42" HEIGHT U.N.O., SEE SIM 4/A960.
- 11 30" X 30" ROOF ACCESS (PROVIDED LARGEST PIECE OF EQUIPMENT CAN PASS THROUGH), SEE 17/A920.
- 22" x 30" ATTIC ACCESS PANEL, 1-HR RATED. SEE DETAIL 13/A912.
- 13 FAU ON RAISED PLATFORM 18" A.F.F., SEE DETAIL 5/A960. 14 5/8" TYPE X GYPSUM BOARD BETWEEN HOUSE AND GARAGE
- TO GARAGE DOOR, SEE GENERAL NOTES DIVISION 8B. 15 WASHER DRAIN PAN, DRAIN TO EXTERIOR.
- DRYER VENT, SEE MECHANICAL DRAWINGS FOR DUCT SIZE(S) AND ROUTING, FIGURE AS NOTED.

THROUGHOUT, SEE GENERAL NOTES DIVISION 9B. HOUSE

- 17 INTERIOR FLAT SOFFIT AT 8'-0" U.N.O.
- 18 HANDRAIL, REFER TO DETAIL 3/A960
- 19 GUARDRAIL, REFER TO DETAIL 4/A960
- 20 RECESSED MEDICINE CABINET
- 21 LAUNDRY SHELF, 16" DEEP, +54" HIGH.

## **LEGEND**

# SEE DOOR SCHEDULE, SHEET A800

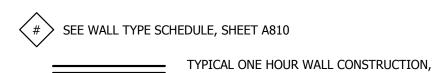

UNPROTECTED OPENING ALLOWED TYPICAL ONE HOUR FIRE PARTITION, PROTECTED OPENINGS REQUIRED

TYPICAL ONE HOUR DWELLING UNIT SEPARATION, PARTY WALL CONSTRUCTION UNLESS NOTED OTHERWISE.

TWO HOUR FIRE WALL CONSTRUCTION

CONTRACTOR TO INSTALL PLEXIGLAS AT BALCONIES ON LEVELS 3 AND 4, AS DETERMINED 2 by noise control requirements. REFER TO REPORT PA-12 FC-2B, ADDENDUM TO PRIOR NOISE STUDY AND EIR PREPARED BY DUDEK. PROVIDE 6' HIGH PLEX-GLASS BARRIER AT BALCONIES AT 3rd AND 4th LEVELS AT BUILDING NUMBERS 11, 12, 21 & 29, FROM SR-125 NOISE AND BUILDING NUMBERS 16 - 19 FROM BRT NOISE PER REPORT.

## UNIT 3 AREA CALCULATIONS

3 BEDROOM / 3 BATH SECOND FLOOR

861 SF THIRD FLOOR
TOTAL LIVING 797 SF 1558 SF SECOND FLOOR DECK TOTAL OUTDOOR

NOTE: CALCULATED FROM EXTERIOR FACE OF UNIT WALL AND EXCLUDES AREAS FOR VERTICAL SHAFTS

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Z

EVELOPME DIEGO, CA 92121 BUILDING
DRIVE SUITE 305 HERITAGE 4350 EXECUTIVE D

Revisions: 03/15/2016
CLIENT MODIFICATIONS


07/14/2016 REVISIONS

PLAN CHECK#

CHULA VISTA BR16-0014 THROUGH 0017 Sheet Title: UNIT 3

> FLOOR PLANS & INTERIORS

09/18/15 1/4" = 1'-0" Scale: Drawn By:

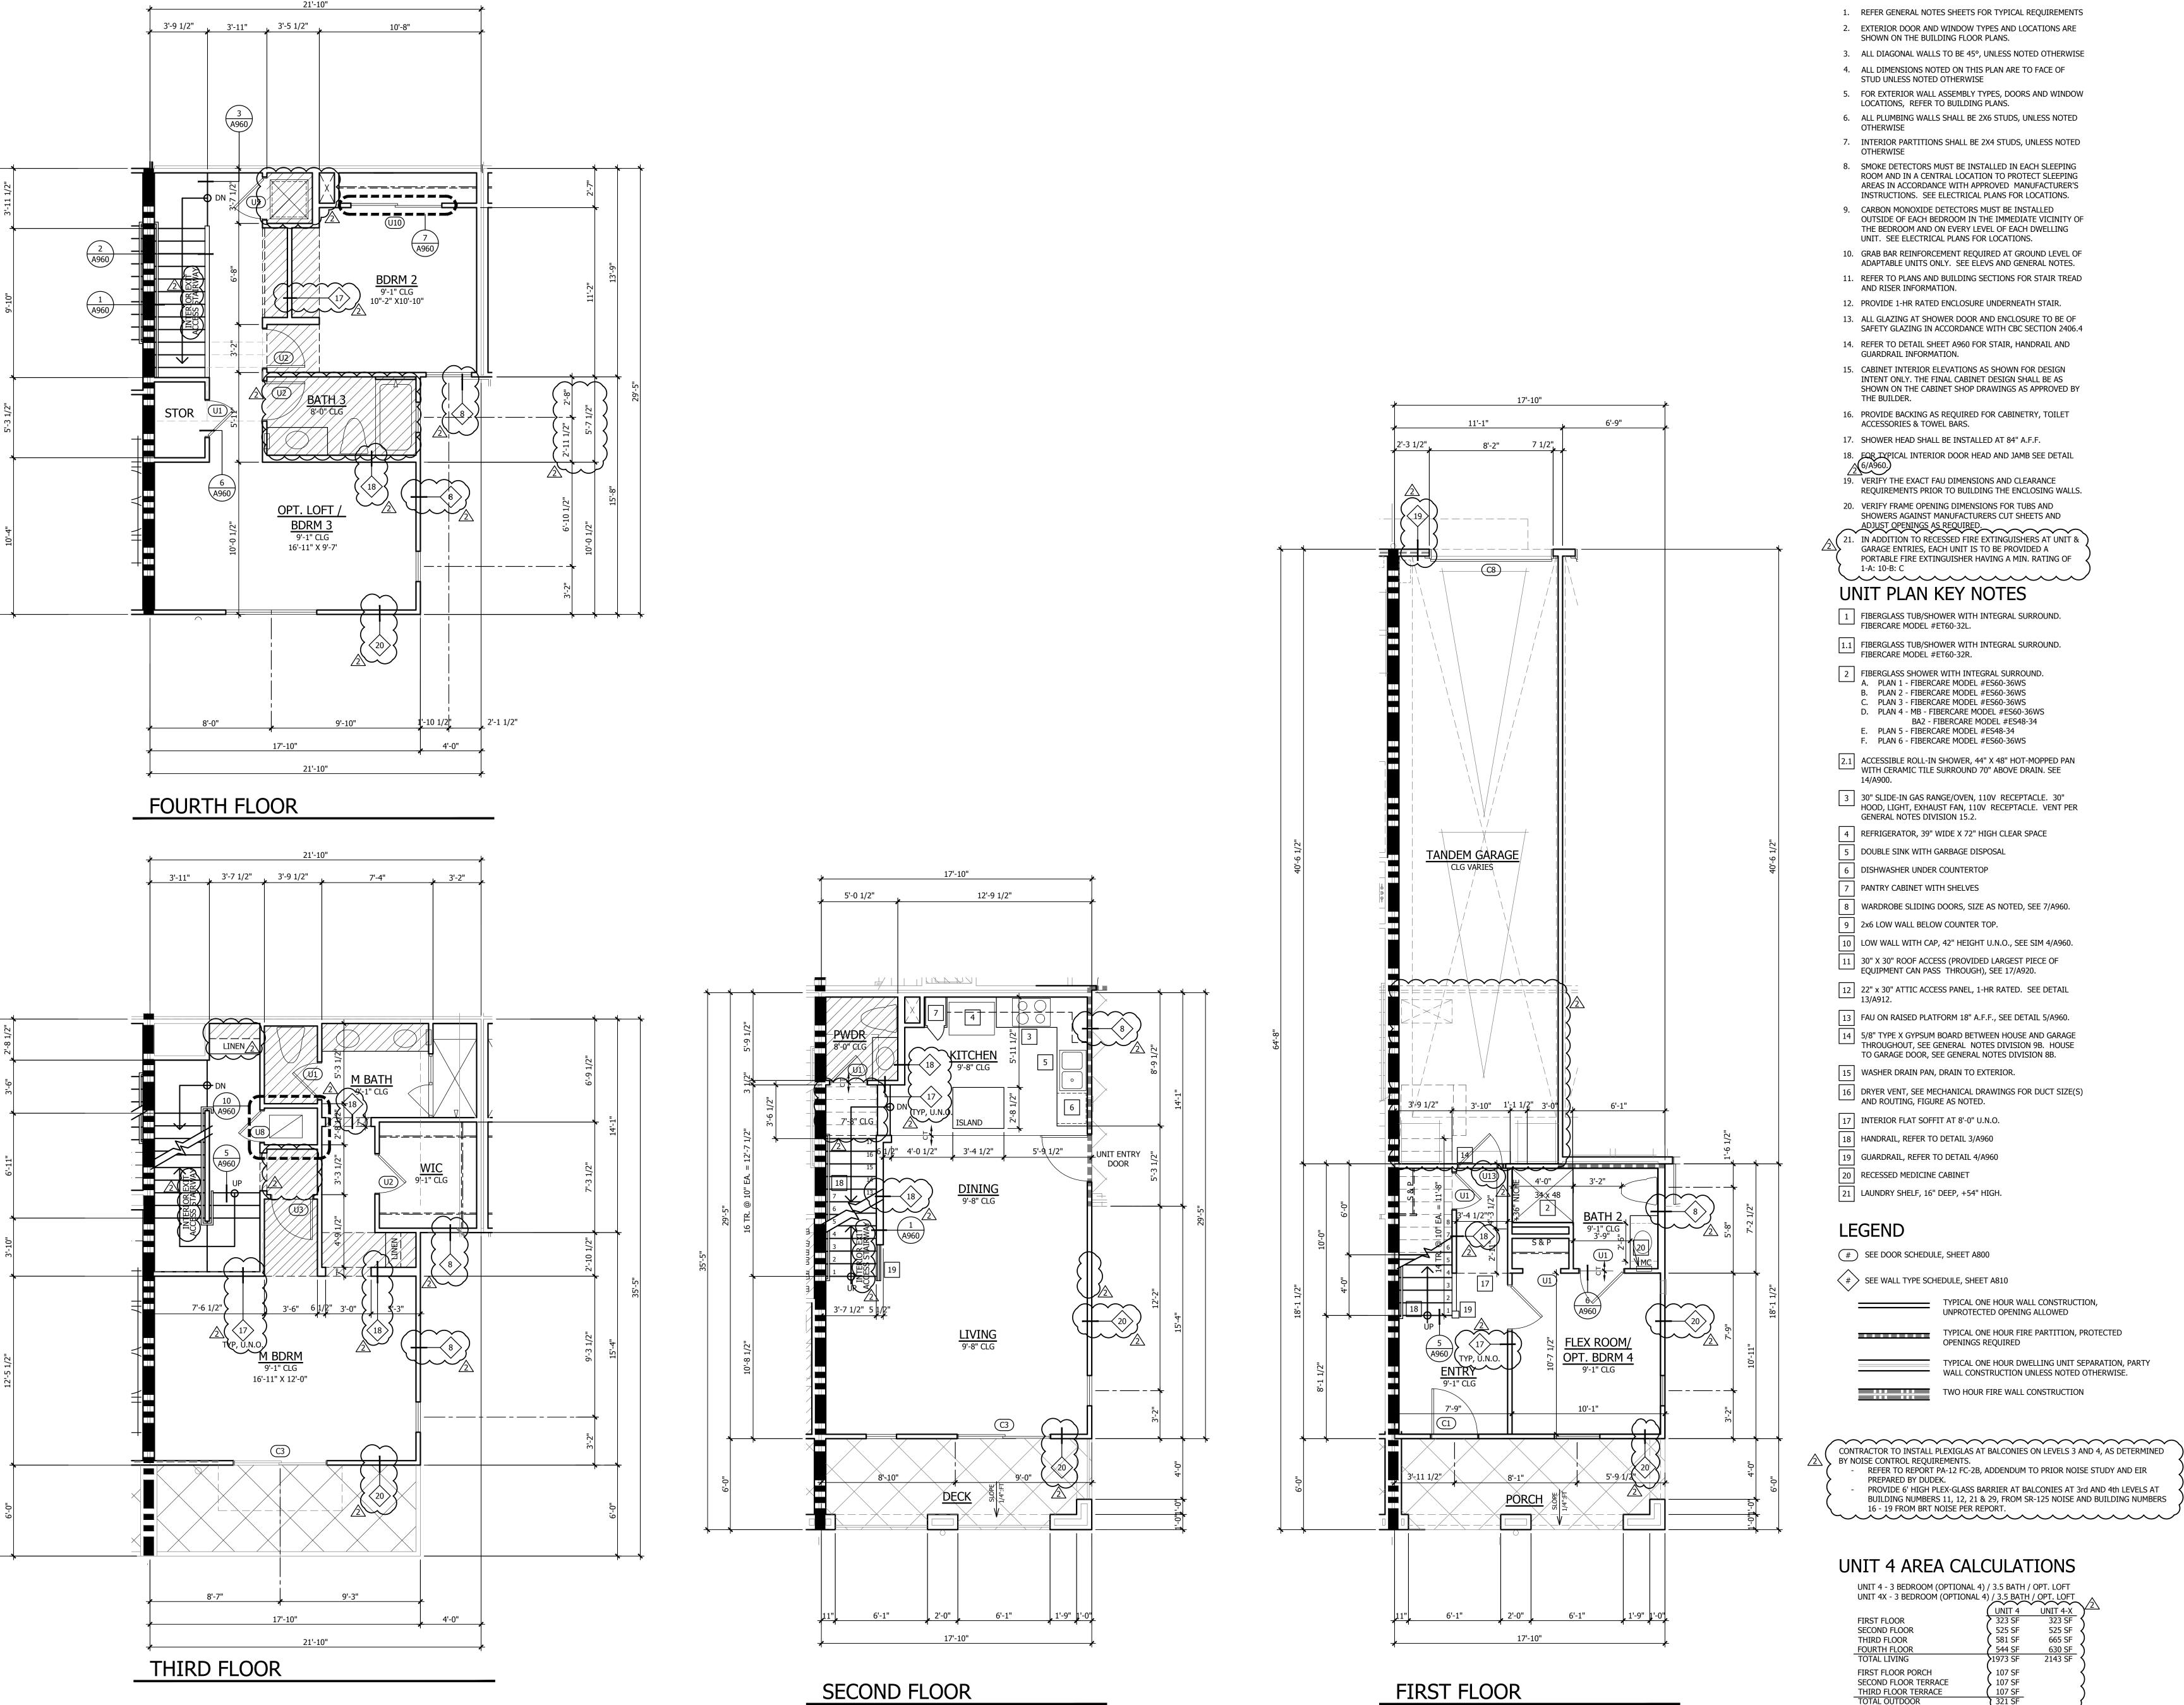

UNIT PLAN GENERAL NOTES

TOTAL OUTDOOR

321 SF

NOTE: CALCULATED FROM EXTERIOR FACE OF UNIT WALL
AND EXCLUDES AREAS FOR VERTICAL SHAFTS

A740

09/18/15

1/4" = 1'-0"

BUILDING
DRIVE SUITE 305

HERITAGE 4350 EXECUTIVE D

Revisions:

PLAN CHECK#


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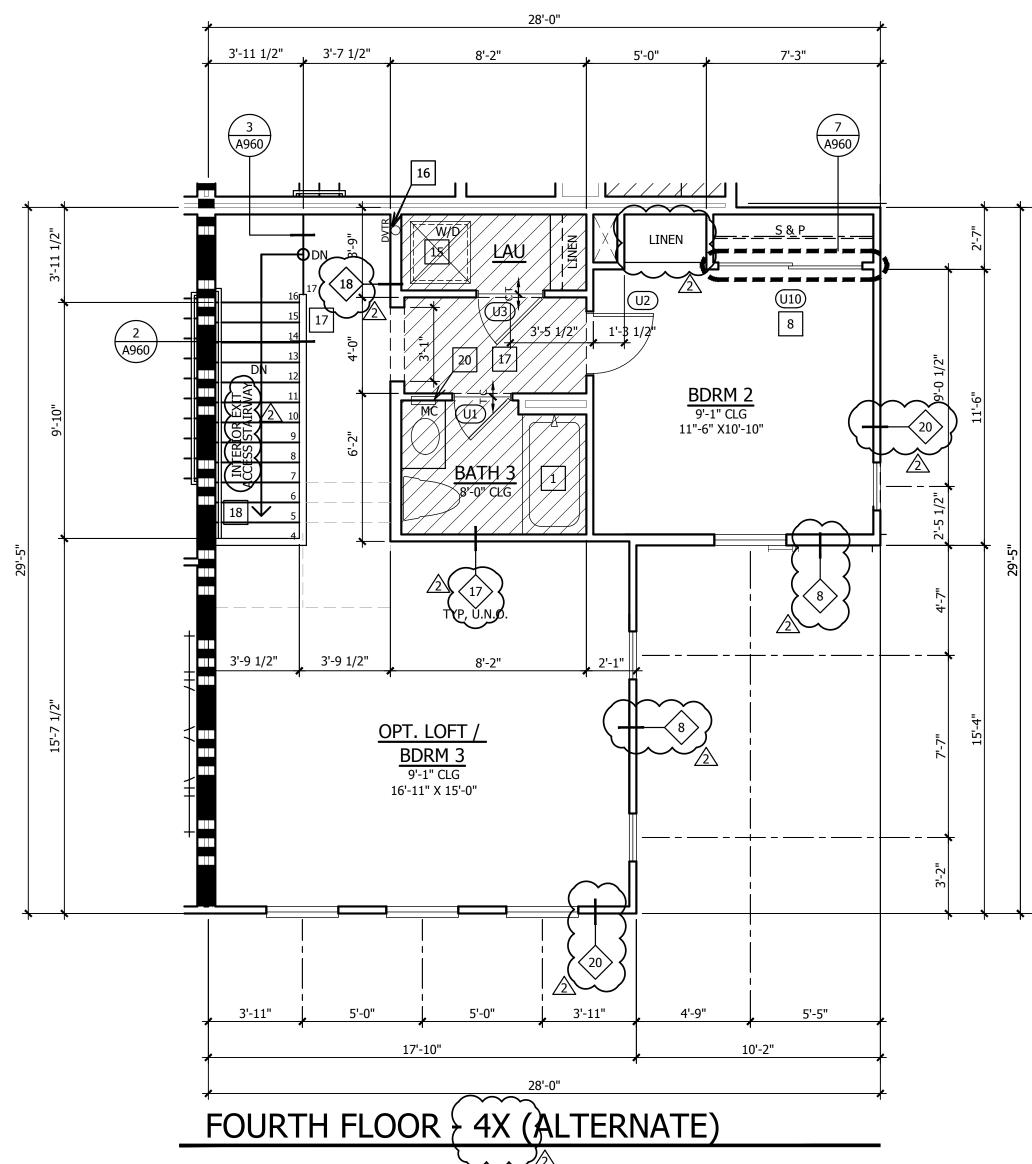
UNIT 4


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CHULA VISTA BR16-0014 THROUGH 0017

FLOOR PLANS





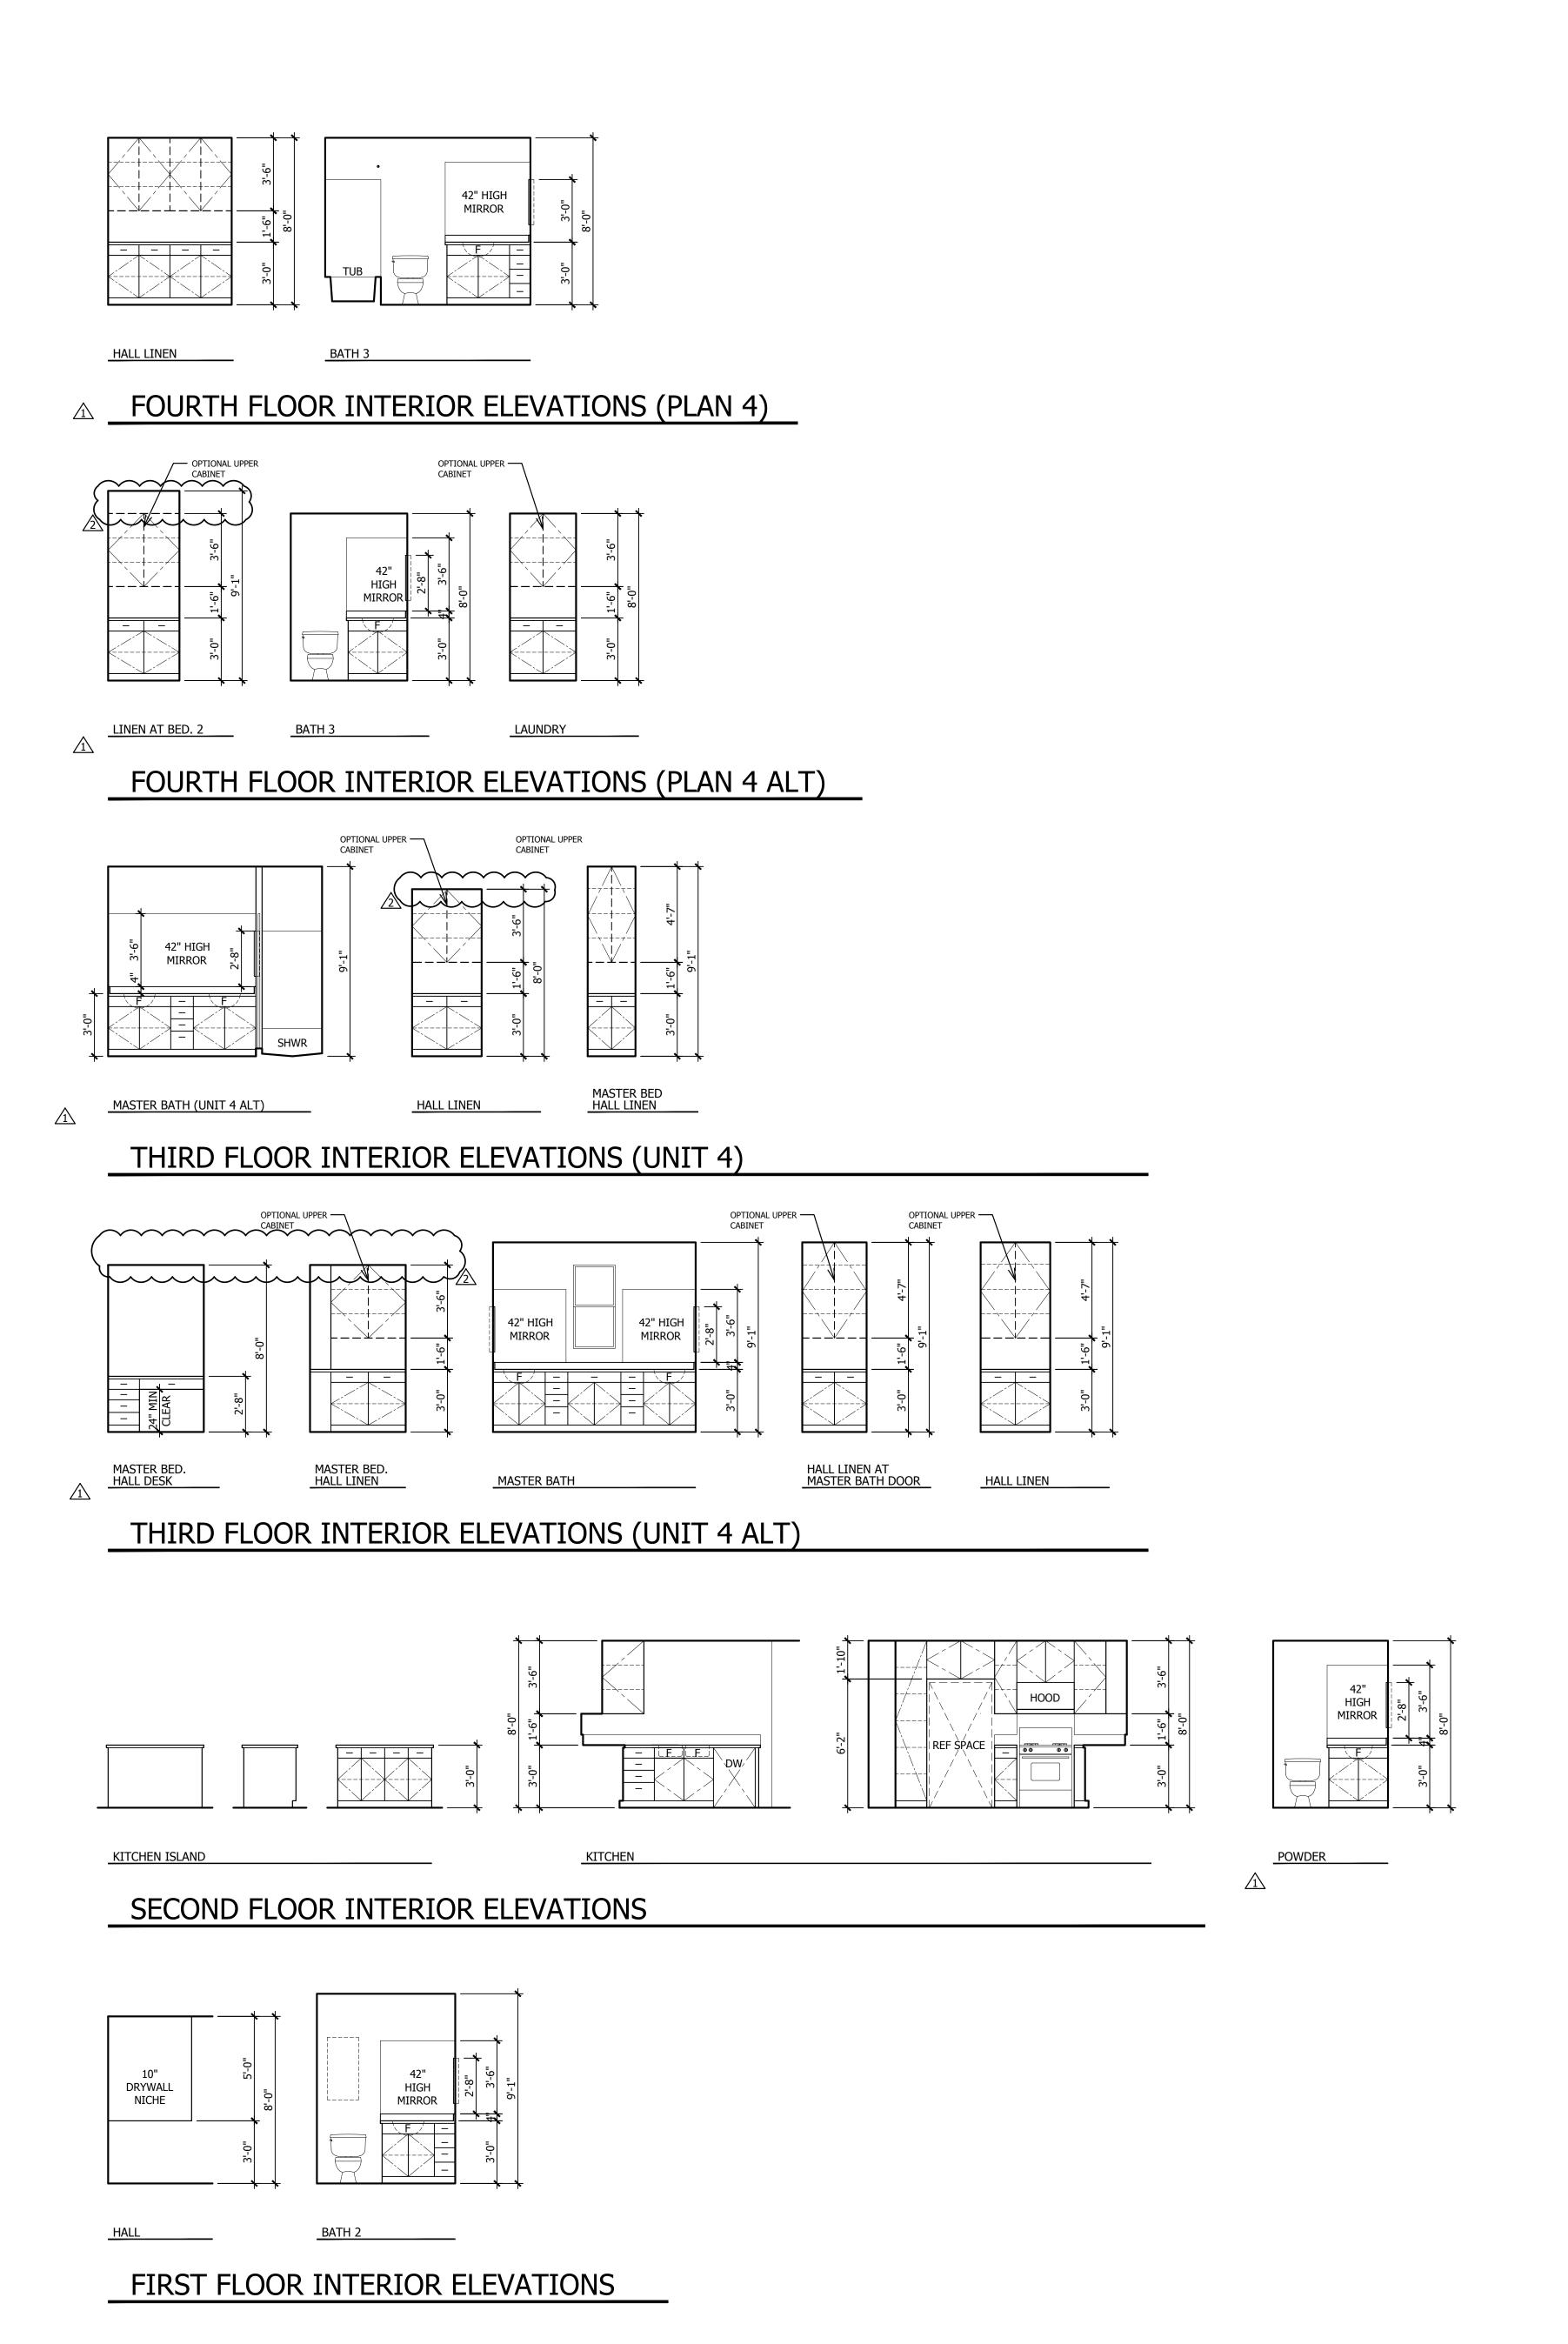
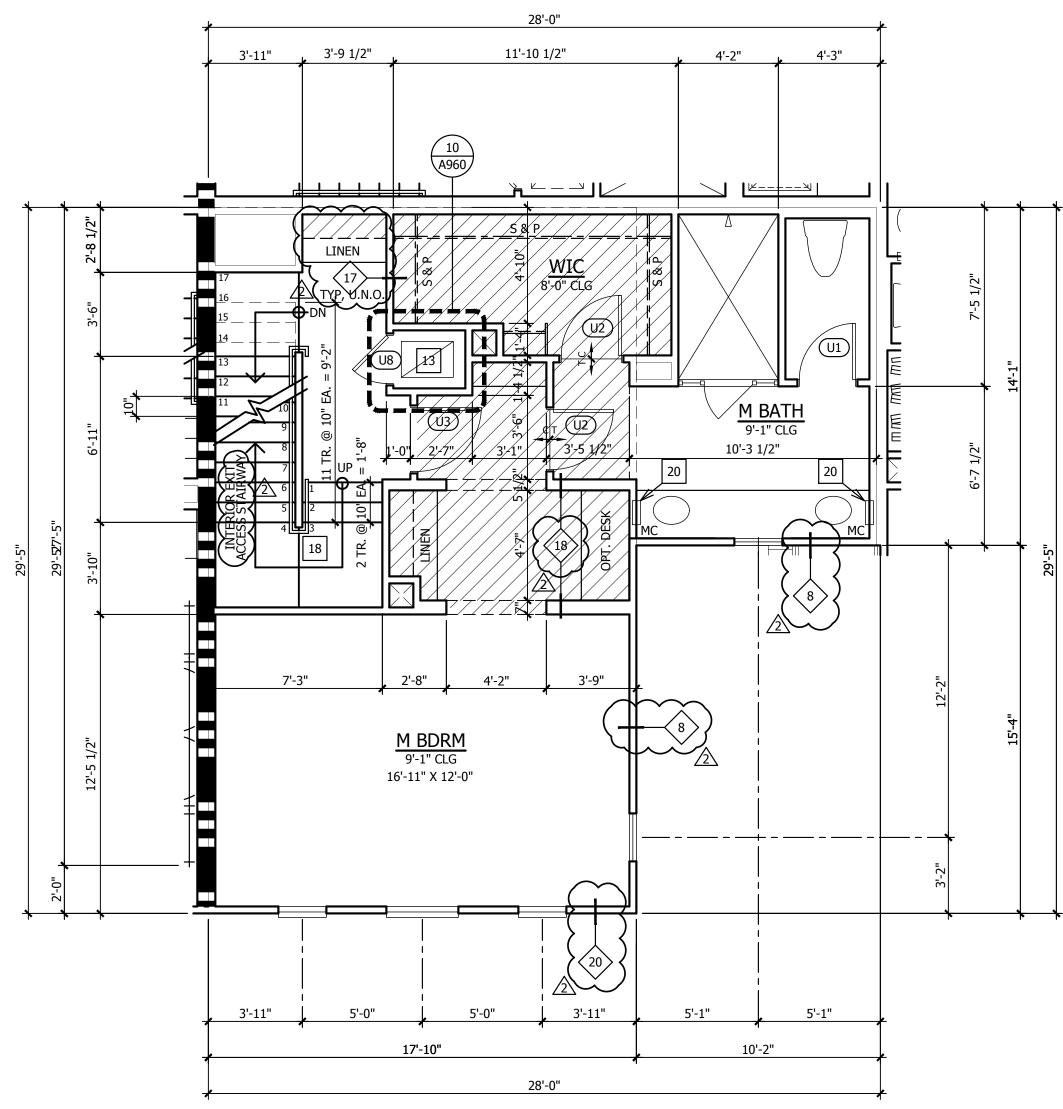
#### UNIT PLAN GENERAL NOTES

- 1. REFER GENERAL NOTES SHEETS FOR TYPICAL REQUIREMENTS 2. EXTERIOR DOOR AND WINDOW TYPES AND LOCATIONS ARE
- SHOWN ON THE BUILDING FLOOR PLANS.
- 3. ALL DIAGONAL WALLS TO BE 45°, UNLESS NOTED OTHERWISE
- 4. ALL DIMENSIONS NOTED ON THIS PLAN ARE TO FACE OF STUD UNLESS NOTED OTHERWISE
- 5. FOR EXTERIOR WALL ASSEMBLY TYPES, DOORS AND WINDOW
- LOCATIONS, REFER TO BUILDING PLANS. 6. ALL PLUMBING WALLS SHALL BE 2X6 STUDS, UNLESS NOTED
- OTHERWISE 7. INTERIOR PARTITIONS SHALL BE 2X4 STUDS, UNLESS NOTED
- 8. SMOKE DETECTORS MUST BE INSTALLED IN EACH SLEEPING ROOM AND IN A CENTRAL LOCATION TO PROTECT SLEEPING AREAS IN ACCORDANCE WITH APPROVED MANUFACTURER'S INSTRUCTIONS. SEE ELECTRICAL PLANS FOR LOCATIONS.
- 9. CARBON MONOXIDE DETECTORS MUST BE INSTALLED OUTSIDE OF EACH BEDROOM IN THE IMMEDIATE VICINITY OF THE BEDROOM AND ON EVERY LEVEL OF EACH DWELLING UNIT. SEE ELECTRICAL PLANS FOR LOCATIONS.
- 10. GRAB BAR REINFORCEMENT REQUIRED AT GROUND LEVEL OF ADAPTABLE UNITS ONLY. SEE ELEVS AND GENERAL NOTES. 11. REFER TO PLANS AND BUILDING SECTIONS FOR STAIR TREAD
- AND RISER INFORMATION. 12. PROVIDE 1-HR RATED ENCLOSURE UNDERNEATH STAIR.
- 13. ALL GLAZING AT SHOWER DOOR AND ENCLOSURE TO BE OF SAFETY GLAZING IN ACCORDANCE WITH CBC SECTION 2406.4
- 14. REFER TO DETAIL SHEET A960 FOR STAIR, HANDRAIL AND GUARDRAIL INFORMATION. 15. CABINET INTERIOR ELEVATIONS AS SHOWN FOR DESIGN
- INTENT ONLY. THE FINAL CABINET DESIGN SHALL BE AS SHOWN ON THE CABINET SHOP DRAWINGS AS APPROVED BY THE BUILDER.
- 16. PROVIDE BACKING AS REQUIRED FOR CABINETRY, TOILET ACCESSORIES & TOWEL BARS.
- 17. SHOWER HEAD SHALL BE INSTALLED AT 84" A.F.F. 18. FOR TYPICAL INTERIOR DOOR HEAD AND JAMB SEE DETAIL
- 19. VERIFY THE EXACT FAU DIMENSIONS AND CLEARANCE REQUIREMENTS PRIOR TO BUILDING THE ENCLOSING WALLS.
- 20. VERIFY FRAME OPENING DIMENSIONS FOR TUBS AND SHOWERS AGAINST MANUFACTURERS CUT SHEETS AND
- ADJUST OPENINGS AS REQUIRED. 21. IN ADDITION TO RECESSED FIRE EXTINGUISHERS AT UNIT & GARAGE ENTRIES, EACH UNIT IS TO BE PROVIDED A PORTABLE FIRE EXTINGUISHER HAVING A MIN. RATING OF

#### UNIT PLAN KEY NOTES

1-A: 10-B: C

- 1 FIBERGLASS TUB/SHOWER WITH INTEGRAL SURROUND. ─ FIBERCARE MODEL #ET60-32L.
- 1.1 FIBERGLASS TUB/SHOWER WITH INTEGRAL SURROUND. FIBERCARE MODEL #ET60-32R.
- 2 FIBERGLASS SHOWER WITH INTEGRAL SURROUND. A. PLAN 1 - FIBERCARE MODEL #ES60-36WS B. PLAN 2 - FIBERCARE MODEL #ES60-36WS C. PLAN 3 - FIBERCARE MODEL #ES60-36WS
- D. PLAN 4 MB FIBERCARE MODEL #ES60-36WS BA2 - FIBERCARE MODEL #ES48-34 E. PLAN 5 - FIBERCARE MODEL #ES48-34 F. PLAN 6 - FIBERCARE MODEL #ES60-36WS
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- 6 DISHWASHER UNDER COUNTERTOP
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- 9 2x6 LOW WALL BELOW COUNTER TOP. 10 LOW WALL WITH CAP, 42" HEIGHT U.N.O., SEE SIM 4/A960.
- 30" X 30" ROOF ACCESS (PROVIDED LARGEST PIECE OF EQUIPMENT CAN PASS THROUGH), SEE 17/A920.
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- DRYER VENT, SEE MECHANICAL DRAWINGS FOR DUCT SIZE(S) AND ROUTING, FIGURE AS NOTED.

THROUGHOUT, SEE GENERAL NOTES DIVISION 9B. HOUSE

- 17 INTERIOR FLAT SOFFIT AT 8'-0" U.N.O.
- 18 HANDRAIL, REFER TO DETAIL 3/A960
- 19 GUARDRAIL, REFER TO DETAIL 4/A960 20 RECESSED MEDICINE CABINET
- 21 LAUNDRY SHELF, 16" DEEP, +54" HIGH.

# **LEGEND**

(#) SEE DOOR SCHEDULE, SHEET A800

# SEE WALL TYPE SCHEDULE, SHEET A810 TYPICAL ONE HOUR WALL CONSTRUCTION,

UNPROTECTED OPENING ALLOWED TYPICAL ONE HOUR FIRE PARTITION, PROTECTED OPENINGS REQUIRED

TYPICAL ONE HOUR DWELLING UNIT SEPARATION, PARTY WALL CONSTRUCTION UNLESS NOTED OTHERWISE. TWO HOUR FIRE WALL CONSTRUCTION

CONTRACTOR TO INSTALL PLEXIGLAS AT BALCONIES ON LEVELS 3 AND 4, AS DETERMINED

REFER TO REPORT PA-12 FC-2B, ADDENDUM TO PRIOR NOISE STUDY AND EIR PREPARED BY DUDEK. PROVIDE 6' HIGH PLEX-GLASS BARRIER AT BALCONIES AT 3rd AND 4th LEVELS AT BUILDING NUMBERS 11, 12, 21 & 29, FROM SR-125 NOISE AND BUILDING NUMBERS 16 - 19 FROM BRT NOISE PER REPORT. 

## UNIT 4 AREA CALCULATIONS

UNIT 4 - 3 BEDROOM (OPTIONAL 4) / 3.5 BATH / OPT. LOFT UNIT 4X - 3 BEDROOM (OPTIONAL 4) / 3.5 BATH / OPT. LOFT FIRST FLOOR SECOND FLOOR 525 SF 525 SF THIRD FLOOR 581 SF 665 SF FIRST FLOOR PORCH 107 SF SECOND FLOOR TERRACE 107 SF

NOTE: CALCULATED FROM EXTERIOR FACE OF UNIT WALL

AND EXCLUDES AREAS FOR VERTICAL SHAFTS

THIRD FLOOR TERRACE TOTAL OUTDOOR

BUILDING DRIVE SUITE 305

HERITAGE 4350 EXECUTIVE D

03/15/2016 CLIENT MODIFICATIONS

07/14/2016 REVISIONS

PLAN CHECK#


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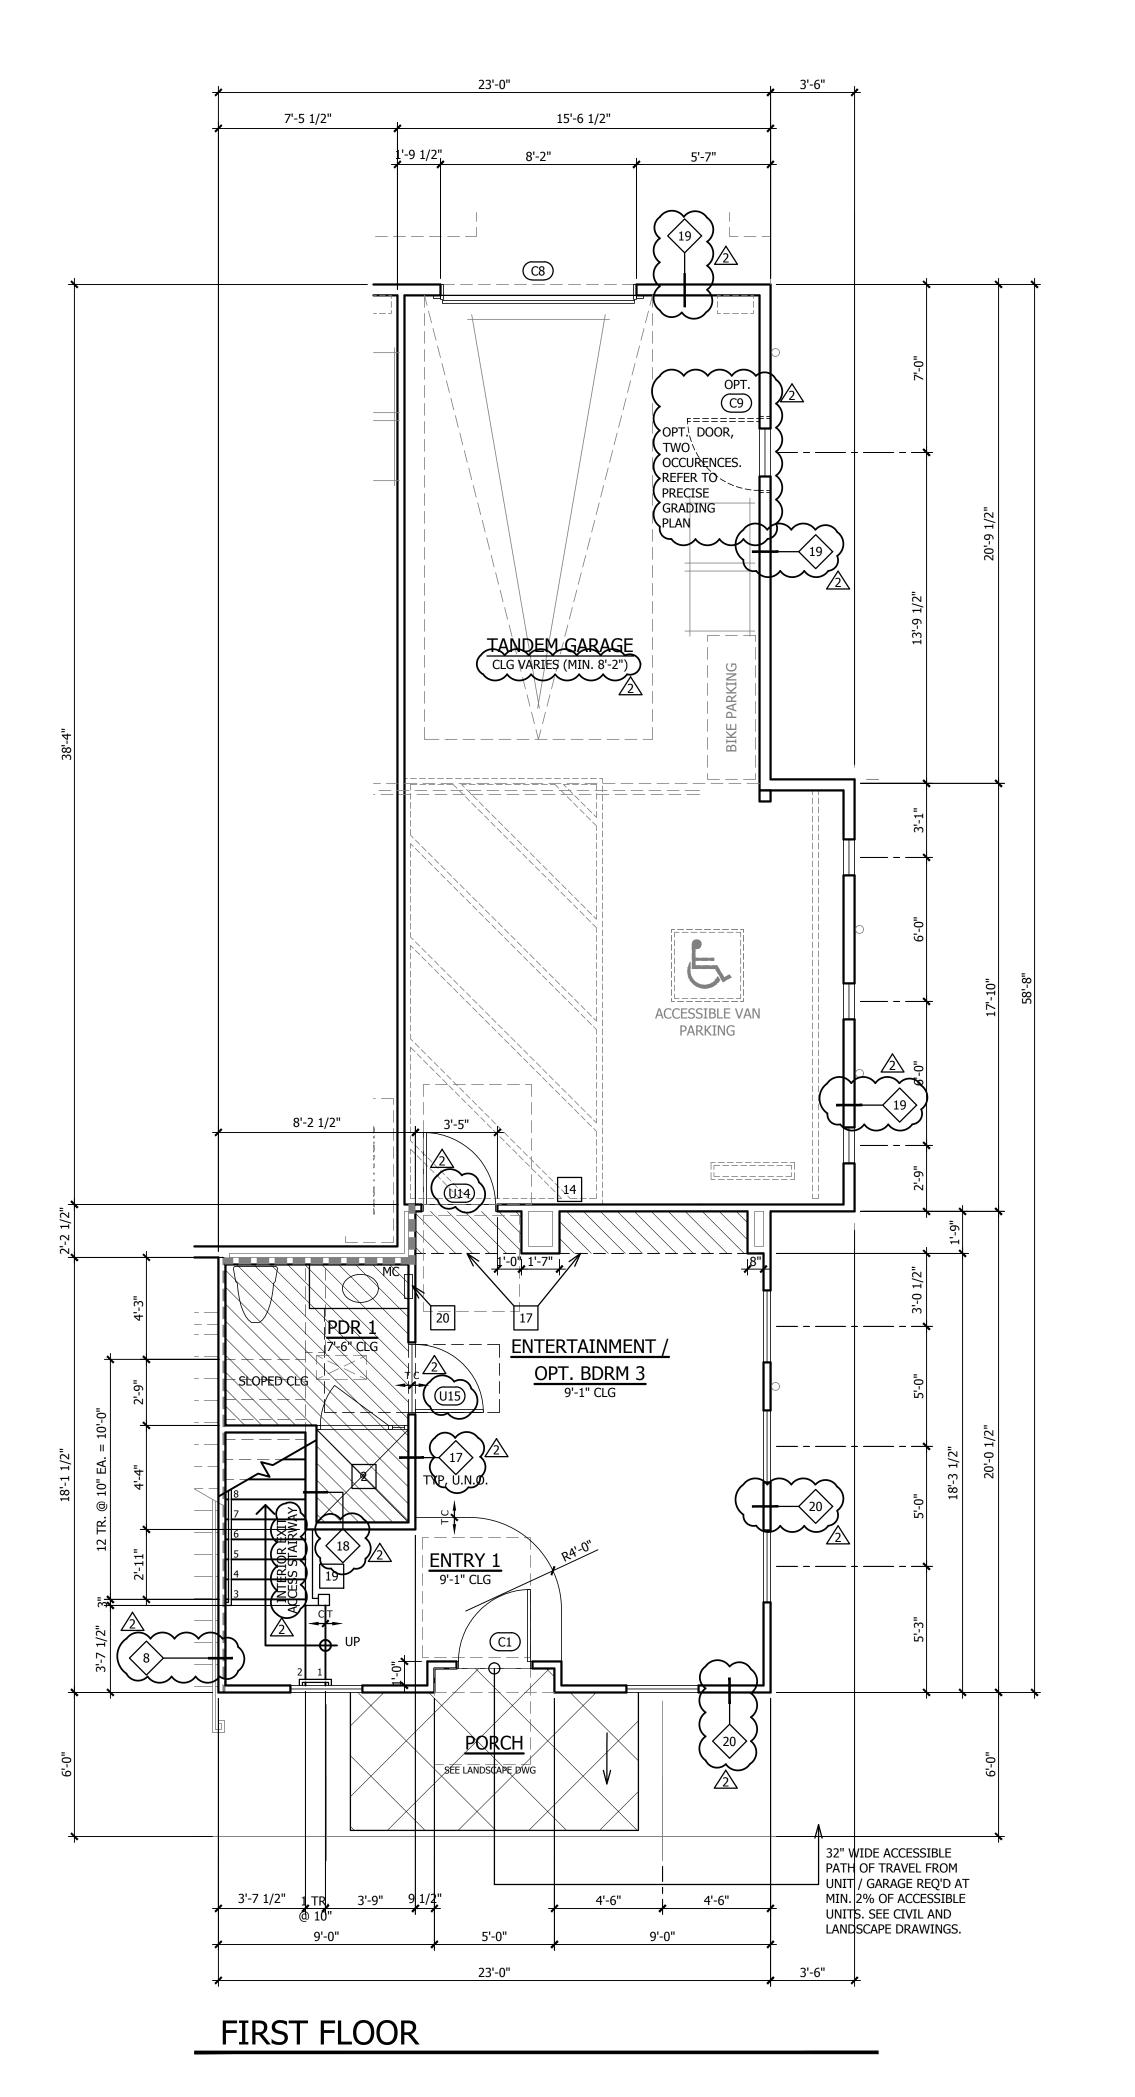
**UNIT 4 ALT** 

FLOOR PLANS

& INTERIORS

CHULA VISTA BR16-0014 THROUGH 0017



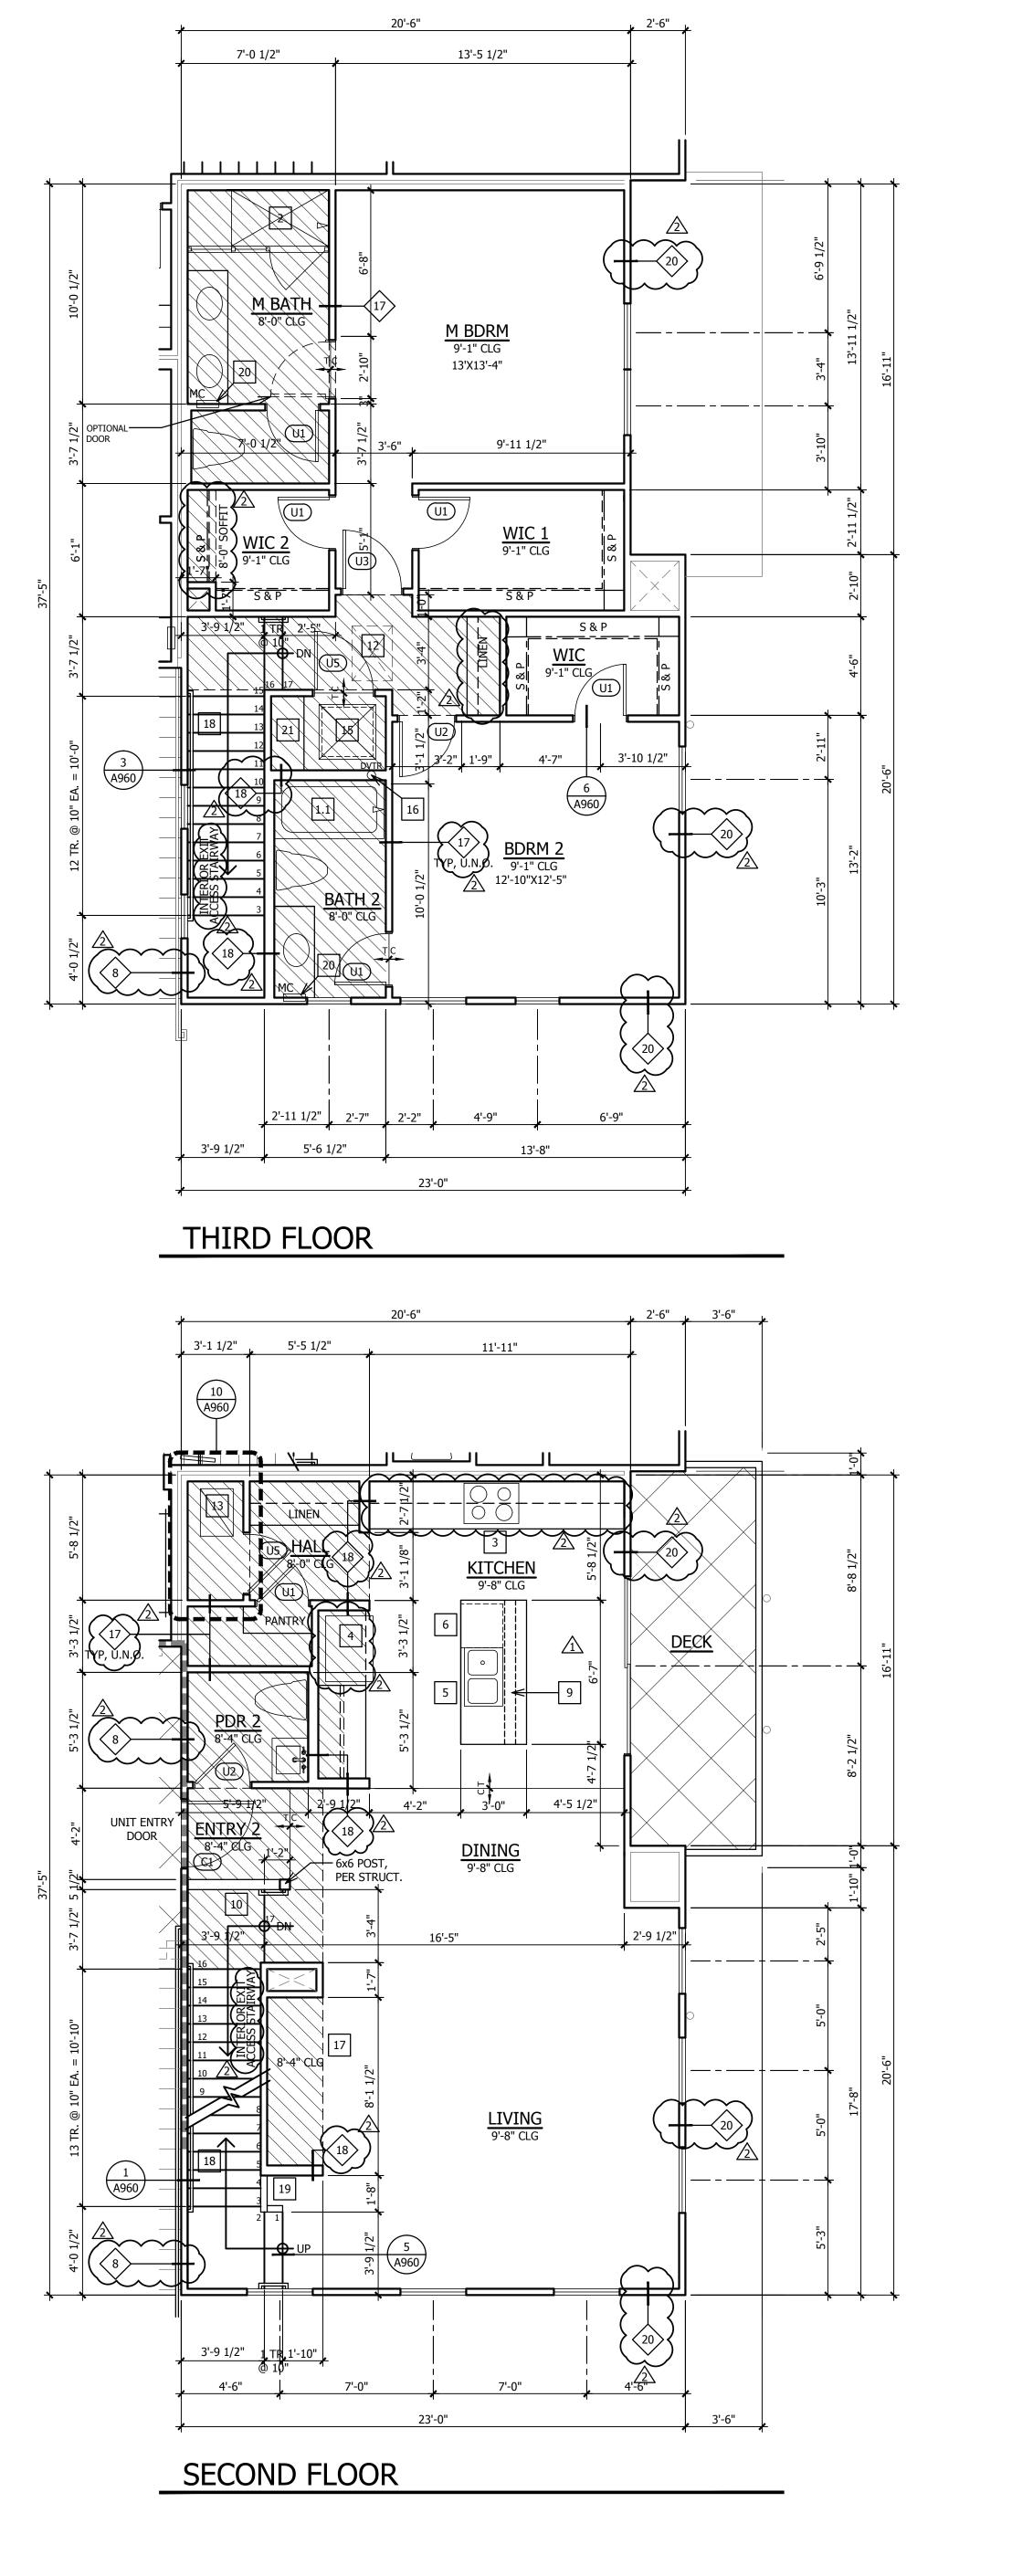

## UNIT PLAN GENERAL NOTES

- 1. REFER GENERAL NOTES SHEETS FOR TYPICAL REQUIREMENTS 2. EXTERIOR DOOR AND WINDOW TYPES AND LOCATIONS ARE
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- 3. ALL DIAGONAL WALLS TO BE 45°, UNLESS NOTED OTHERWISE
- 4. ALL DIMENSIONS NOTED ON THIS PLAN ARE TO FACE OF STUD UNLESS NOTED OTHERWISE
- 5. FOR EXTERIOR WALL ASSEMBLY TYPES, DOORS AND WINDOW LOCATIONS, REFER TO BUILDING PLANS.
- 6. ALL PLUMBING WALLS SHALL BE 2X6 STUDS, UNLESS NOTED OTHERWISE 7. INTERIOR PARTITIONS SHALL BE 2X4 STUDS, UNLESS NOTED

OTHERWISE

- 8. SMOKE DETECTORS MUST BE INSTALLED IN EACH SLEEPING ROOM AND IN A CENTRAL LOCATION TO PROTECT SLEEPING AREAS IN ACCORDANCE WITH APPROVED MANUFACTURER'S INSTRUCTIONS. SEE ELECTRICAL PLANS FOR LOCATIONS.
- 9. CARBON MONOXIDE DETECTORS MUST BE INSTALLED OUTSIDE OF EACH BEDROOM IN THE IMMEDIATE VICINITY OF THE BEDROOM AND ON EVERY LEVEL OF EACH DWELLING UNIT. SEE ELECTRICAL PLANS FOR LOCATIONS.
- 10. GRAB BAR REINFORCEMENT REQUIRED AT GROUND LEVEL OF ADAPTABLE UNITS ONLY. SEE ELEVS AND GENERAL NOTES. 11. REFER TO PLANS AND BUILDING SECTIONS FOR STAIR TREAD
- AND RISER INFORMATION. 12. PROVIDE 1-HR RATED ENCLOSURE UNDERNEATH STAIR.
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14. REFER TO DETAIL SHEET A960 FOR STAIR, HANDRAIL AND

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- 17. SHOWER HEAD SHALL BE INSTALLED AT 84" A.F.F. 18. FOR TYPICAL INTERIOR DOOR HEAD AND JAMB SEE DETAIL
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  21. IN ADDITION TO RECESSED FIRE EXTINGUISHERS AT UNIT & GARAGE ENTRIES, EACH UNIT IS TO BE PROVIDED A PORTABLE FIRE EXTINGUISHER HAVING A MIN. RATING OF 1-A: 10-B: C

#### UNIT PLAN KEY NOTES

- 1 FIBERGLASS TUB/SHOWER WITH INTEGRAL SURROUND. J FIBERCARE MODEL #ET60-32L.
- 1.1 FIBERGLASS TUB/SHOWER WITH INTEGRAL SURROUND. FIBERCARE MODEL #ET60-32R.
- 2 | FIBERGLASS SHOWER WITH INTEGRAL SURROUND. A. PLAN 1 - FIBERCARE MODEL #ES60-36WS B. PLAN 2 - FIBERCARE MODEL #ES60-36WS
- C. PLAN 3 FIBERCARE MODEL #ES60-36WS D. PLAN 4 - MB - FIBERCARE MODEL #ES60-36WS BA2 - FIBERCARE MODEL #ES48-34 E. PLAN 5 - FIBERCARE MODEL #ES48-34
- F. PLAN 6 FIBERCARE MODEL #ES60-36WS 2.1 ACCESSIBLE ROLL-IN SHOWER, 44" X 48" HOT-MOPPED PAN WITH CERAMIC TILE SURROUND 70" ABOVE DRAIN. SEE
- 3 30" SLIDE-IN GAS RANGE/OVEN, 110V RECEPTACLE. 30" HOOD, LIGHT, EXHAUST FAN, 110V RECEPTACLE. VENT PER
- GENERAL NOTES DIVISION 15.2. 4 REFRIGERATOR, 39" WIDE X 72" HIGH CLEAR SPACE
- DOUBLE SINK WITH GARBAGE DISPOSAL
- 6 DISHWASHER UNDER COUNTERTOP
- PANTRY CABINET WITH SHELVES
- 8 WARDROBE SLIDING DOORS, SIZE AS NOTED, SEE 7/A960. 9 2x6 LOW WALL BELOW COUNTER TOP.
- 10 LOW WALL WITH CAP, 42" HEIGHT U.N.O., SEE SIM 4/A960.
- 30" X 30" ROOF ACCESS (PROVIDED LARGEST PIECE OF EQUIPMENT CAN PASS THROUGH), SEE 17/A920.
- 22" x 30" ATTIC ACCESS PANEL, 1-HR RATED. SEE DETAIL 13/A912.
- 13 FAU ON RAISED PLATFORM 18" A.F.F., SEE DETAIL 5/A960. 14 5/8" TYPE X GYPSUM BOARD BETWEEN HOUSE AND GARAGE
- TO GARAGE DOOR, SEE GENERAL NOTES DIVISION 8B. 15 WASHER DRAIN PAN, DRAIN TO EXTERIOR.
- 16 DRYER VENT, SEE MECHANICAL DRAWINGS FOR DUCT SIZE(S)

THROUGHOUT, SEE GENERAL NOTES DIVISION 9B. HOUSE

- AND ROUTING, FIGURE AS NOTED.
- 17 INTERIOR FLAT SOFFIT AT 8'-0" U.N.O.
- 18 HANDRAIL, REFER TO DETAIL 3/A960 19 GUARDRAIL, REFER TO DETAIL 4/A960
- 20 RECESSED MEDICINE CABINET
- 21 LAUNDRY SHELF, 16" DEEP, +54" HIGH.

## LEGEND

# SEE DOOR SCHEDULE, SHEET A800

SEE WALL TYPE SCHEDULE, SHEET A810

TYPICAL ONE HOUR WALL CONSTRUCTION, UNPROTECTED OPENING ALLOWED TYPICAL ONE HOUR FIRE PARTITION, PROTECTED

OPENINGS REQUIRED TYPICAL ONE HOUR DWELLING UNIT SEPARATION, PARTY WALL CONSTRUCTION UNLESS NOTED OTHERWISE.

TWO HOUR FIRE WALL CONSTRUCTION

CONTRACTOR TO INSTALL PLEXIGLAS AT BALCONIES ON LEVELS 3 AND 4, AS DETERMINED BY NOISE CONTROL REQUIREMENTS. REFER TO REPORT PA-12 FC-2B, ADDENDUM TO PRIOR NOISE STUDY AND EIR PREPARED BY DUDEK. PROVIDE 6' HIGH PLEX-GLASS BARRIER AT BALCONIES AT 3rd AND 4th LEVELS AT BUILDING NUMBERS 11, 12, 21 & 29, FROM SR-125 NOISE AND BUILDING NUMBERS 16 - 19 FROM BRT NOISE PER REPORT.

## UNIT 5 AREA CALCULATIONS

2 BEDROOM (OPTIONAL 3) / 3.5 BATH / ENTERTAINMENT RM FIRST FLOOR 812 SF SECOND FLOOR FIRST FLOOR PATIO

AND EXCLUDES AREAS FOR VERTICAL SHAFTS

SECOND FLOOR DECK
TOTAL OUTDOOR NOTE: CALCULATED FROM EXTERIOR FACE OF UNIT WALL



BUILDING
DRIVE SUITE 305 HERITAGE 4350 EXECUTIVE D




Revisions: 03/15/2016
CLIENT MODIFICATIONS 07/14/2016 REVISIONS

PLAN CHECK# CHULA VISTA BR16-0014 THROUGH 0017 Sheet Title:

UNIT 5 FLOOR PLANS (ACCESSIBLE UNIT)

09/18/15 Scale: 1/4" = 1'-0" Drawn By:

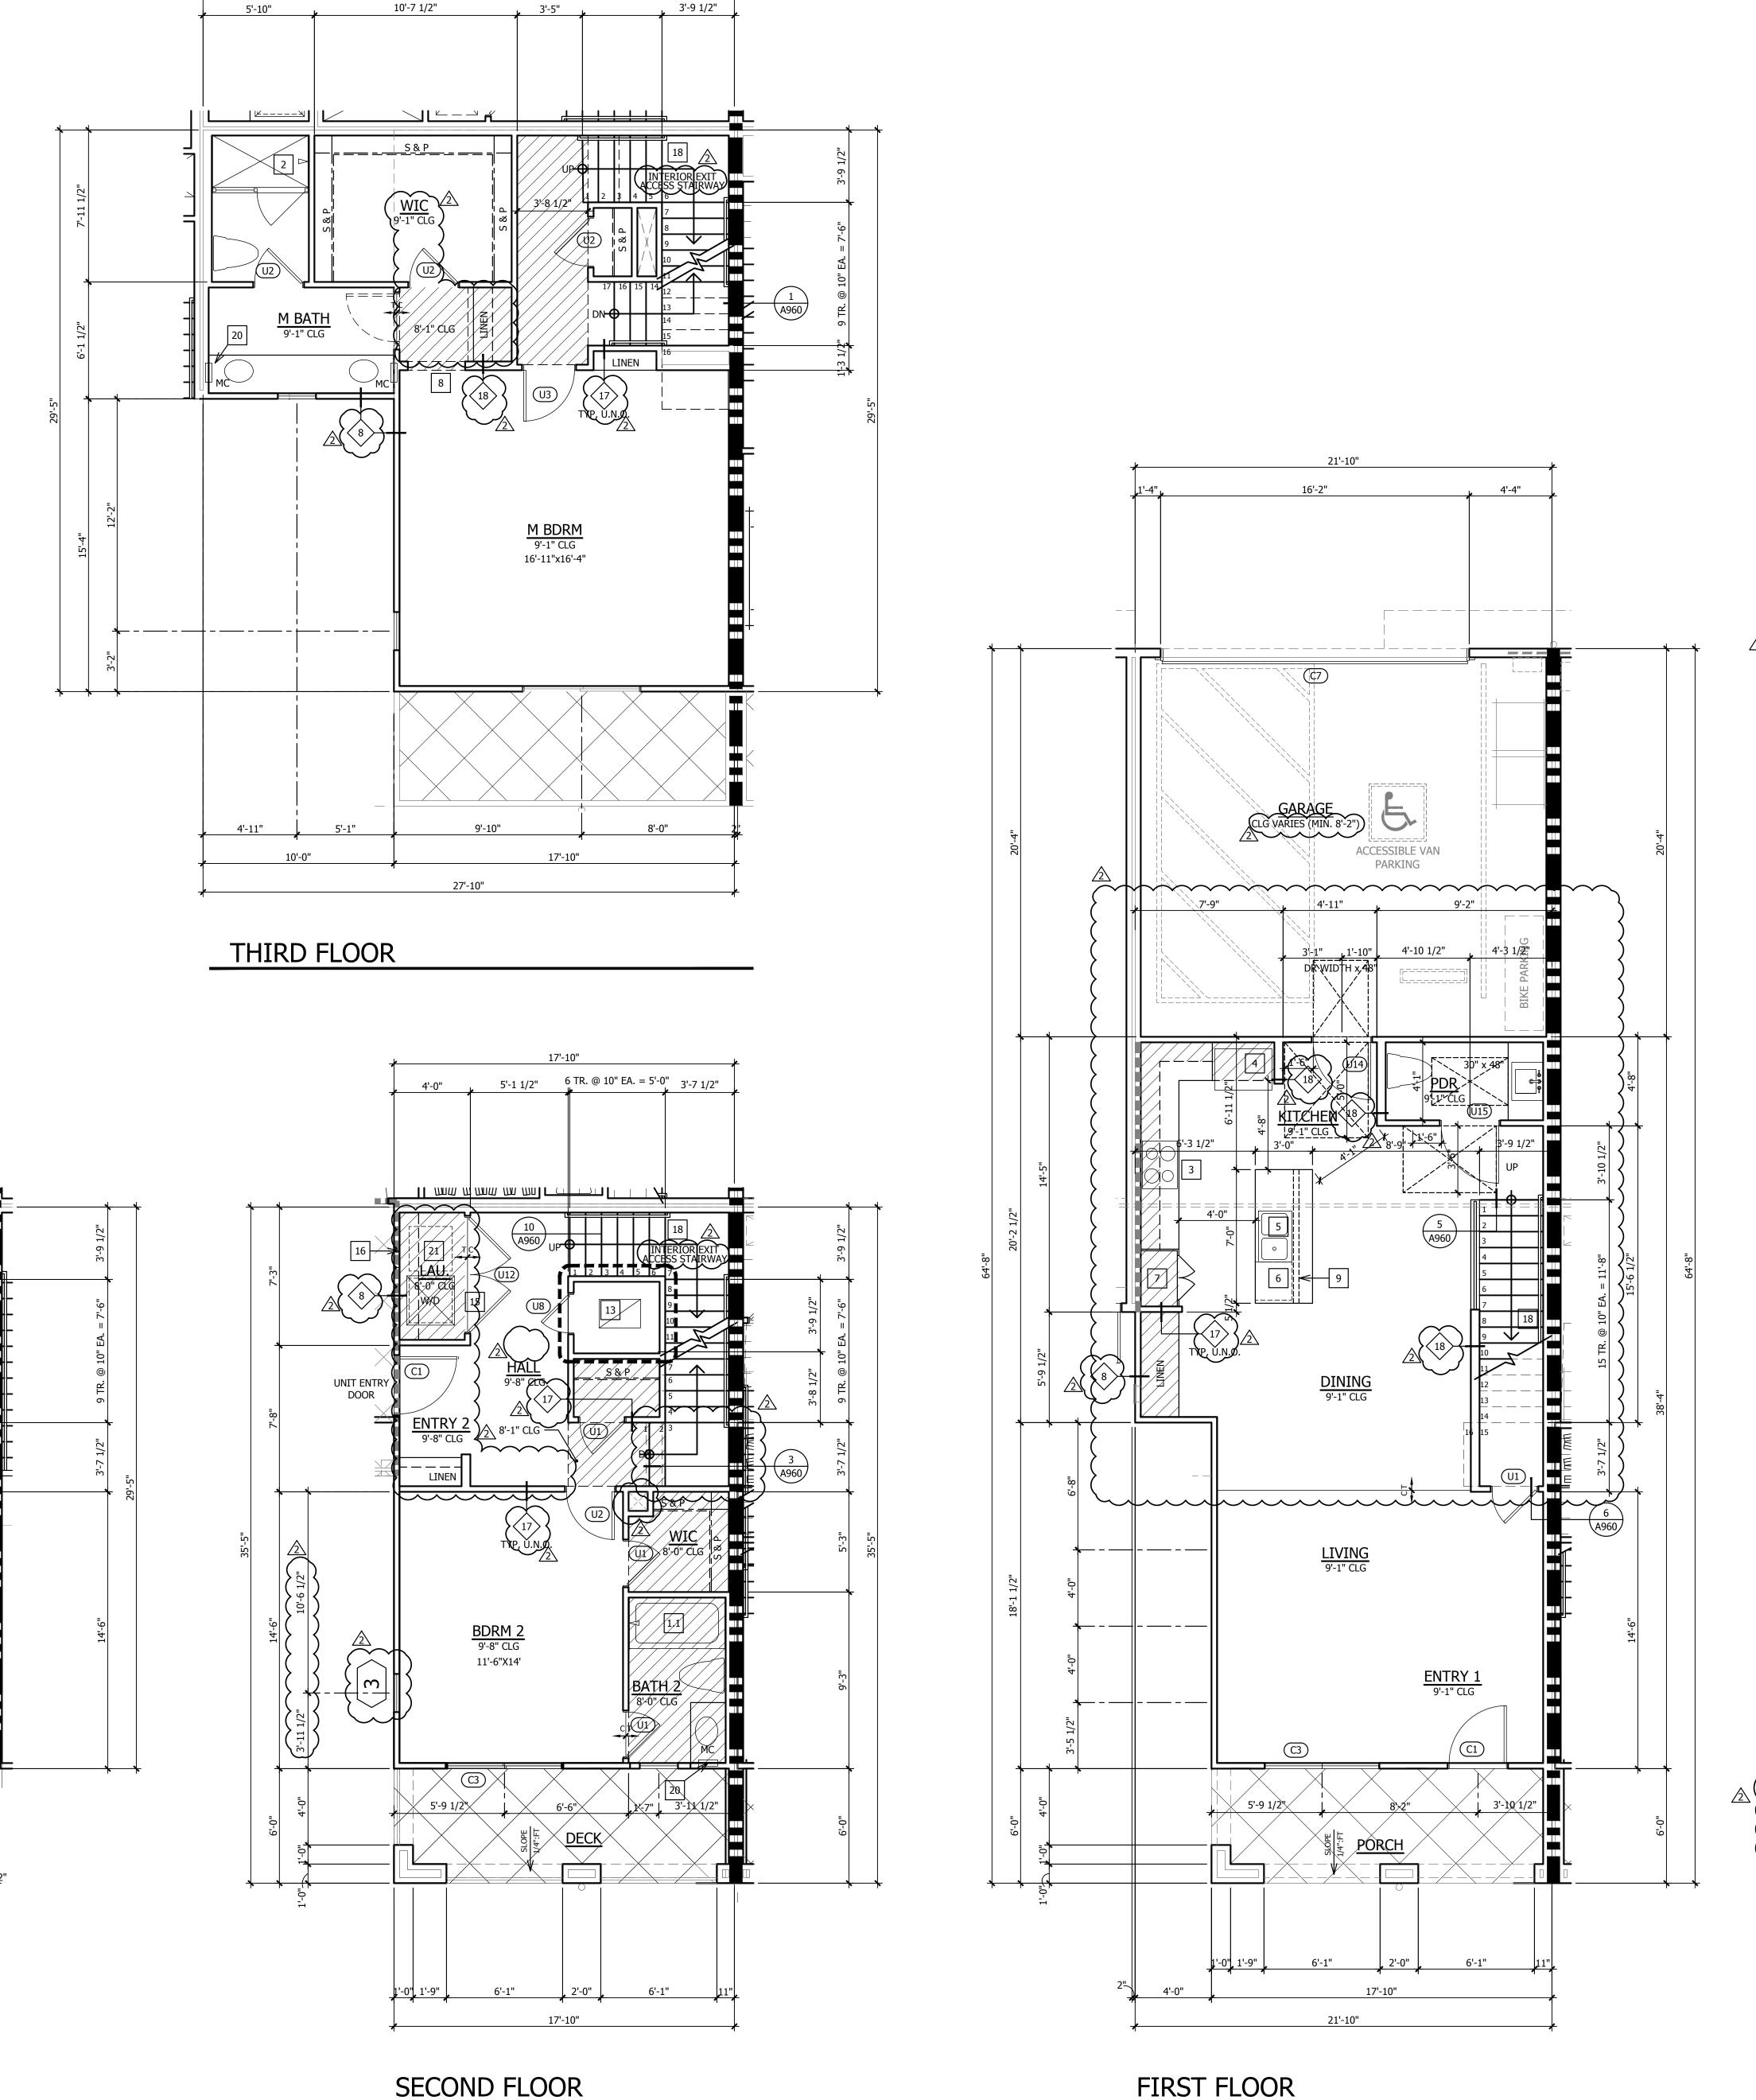

5 TR. @ 10" EA. = 4'-2"

11'-5 1/2"

BDRM 4 9'-1" CLG 11'x10'-6"

FOURTH FLOOR

2'-7" م 3'-9 1/2"

11'-6"x14'

UNIT PLAN GENERAL NOTES

1. REFER GENERAL NOTES SHEETS FOR TYPICAL REQUIREMENTS 2. EXTERIOR DOOR AND WINDOW TYPES AND LOCATIONS ARE

SHOWN ON THE BUILDING FLOOR PLANS.

3. ALL DIAGONAL WALLS TO BE 45°, UNLESS NOTED OTHERWISE

4. ALL DIMENSIONS NOTED ON THIS PLAN ARE TO FACE OF STUD UNLESS NOTED OTHERWISE

5. FOR EXTERIOR WALL ASSEMBLY TYPES, DOORS AND WINDOW LOCATIONS, REFER TO BUILDING PLANS.

6. ALL PLUMBING WALLS SHALL BE 2X6 STUDS, UNLESS NOTED OTHERWISE

7. INTERIOR PARTITIONS SHALL BE 2X4 STUDS, UNLESS NOTED OTHERWISE

8. SMOKE DETECTORS MUST BE INSTALLED IN EACH SLEEPING ROOM AND IN A CENTRAL LOCATION TO PROTECT SLEEPING AREAS IN ACCORDANCE WITH APPROVED MANUFACTURER'S INSTRUCTIONS. SEE ELECTRICAL PLANS FOR LOCATIONS. 9. CARBON MONOXIDE DETECTORS MUST BE INSTALLED

OUTSIDE OF EACH BEDROOM IN THE IMMEDIATE VICINITY OF THE BEDROOM AND ON EVERY LEVEL OF EACH DWELLING UNIT. SEE ELECTRICAL PLANS FOR LOCATIONS. 10. GRAB BAR REINFORCEMENT REQUIRED AT GROUND LEVEL OF

ADAPTABLE UNITS ONLY. SEE ELEVS AND GENERAL NOTES. 11. REFER TO PLANS AND BUILDING SECTIONS FOR STAIR TREAD AND RISER INFORMATION.

12. PROVIDE 1-HR RATED ENCLOSURE UNDERNEATH STAIR.

13. ALL GLAZING AT SHOWER DOOR AND ENCLOSURE TO BE OF SAFETY GLAZING IN ACCORDANCE WITH CBC SECTION 2406.4 14. REFER TO DETAIL SHEET A960 FOR STAIR, HANDRAIL AND

15. CABINET INTERIOR ELEVATIONS AS SHOWN FOR DESIGN INTENT ONLY. THE FINAL CABINET DESIGN SHALL BE AS SHOWN ON THE CABINET SHOP DRAWINGS AS APPROVED BY THE BUILDER.

16. PROVIDE BACKING AS REQUIRED FOR CABINETRY, TOILET ACCESSORIES & TOWEL BARS.

GUARDRAIL INFORMATION.

17. SHOWER HEAD SHALL BE INSTALLED AT 84" A.F.F. 18. FOR TYPICAL INTERIOR DOOR HEAD AND JAMB SEE DETAIL

19. VERIFY THE EXACT FAU DIMENSIONS AND CLEARANCE REQUIREMENTS PRIOR TO BUILDING THE ENCLOSING WALLS.

20. VERIFY FRAME OPENING DIMENSIONS FOR TUBS AND SHOWERS AGAINST MANUFACTURERS CUT SHEETS AND ADJUST OPENINGS AS REQUIRED.

21. IN ADDITION TO RECESSED FIRE EXTINGUISHERS AT UNIT &

GARAGE ENTRIES, EACH UNIT IS TO BE PROVIDED A PORTABLE FIRE EXTINGUISHER HAVING A MIN. RATING OF

#### UNIT PLAN KEY NOTES

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1.1 FIBERGLASS TUB/SHOWER WITH INTEGRAL SURROUND. J FIBERCARE MODEL #ET60-32R.

1-A: 10-B: C

2 FIBERGLASS SHOWER WITH INTEGRAL SURROUND. A. PLAN 1 - FIBERCARE MODEL #ES60-36WS B. PLAN 2 - FIBERCARE MODEL #ES60-36WS C. PLAN 3 - FIBERCARE MODEL #ES60-36WS D. PLAN 4 - MB - FIBERCARE MODEL #ES60-36WS BA2 - FIBERCARE MODEL #ES48-34 E. PLAN 5 - FIBERCARE MODEL #ES48-34F. PLAN 6 - FIBERCARE MODEL #ES60-36WS

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3 30" SLIDE-IN GAS RANGE/OVEN, 110V RECEPTACLE. 30" HOOD, LIGHT, EXHAUST FAN, 110V RECEPTACLE. VENT PER

GENERAL NOTES DIVISION 15.2. 4 REFRIGERATOR, 39" WIDE X 72" HIGH CLEAR SPACE

5 DOUBLE SINK WITH GARBAGE DISPOSAL 6 DISHWASHER UNDER COUNTERTOP

PANTRY CABINET WITH SHELVES

8 WARDROBE SLIDING DOORS, SIZE AS NOTED, SEE 7/A960. 9 2x6 LOW WALL BELOW COUNTER TOP.

10 LOW WALL WITH CAP, 42" HEIGHT U.N.O., SEE SIM 4/A960.

30" X 30" ROOF ACCESS (PROVIDED LARGEST PIECE OF EQUIPMENT CAN PASS THROUGH), SEE 17/A920.

12 22" x 30" ATTIC ACCESS PANEL, 1-HR RATED. SEE DETAIL

13 FAU ON RAISED PLATFORM 18" A.F.F., SEE DETAIL 5/A960. 14 5/8" TYPE X GYPSUM BOARD BETWEEN HOUSE AND GARAGE THROUGHOUT, SEE GENERAL NOTES DIVISION 9B. HOUSE

TO GARAGE DOOR, SEE GENERAL NOTES DIVISION 8B.

15 WASHER DRAIN PAN, DRAIN TO EXTERIOR.

16 DRYER VENT, SEE MECHANICAL DRAWINGS FOR DUCT SIZE(S)

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17 INTERIOR FLAT SOFFIT AT 8'-0" U.N.O.

18 HANDRAIL, REFER TO DETAIL 3/A960 19 GUARDRAIL, REFER TO DETAIL 4/A960

20 RECESSED MEDICINE CABINET

21 LAUNDRY SHELF, 16" DEEP, +54" HIGH.

## **LEGEND**

# SEE DOOR SCHEDULE, SHEET A800

# SEE WALL TYPE SCHEDULE, SHEET A810

TYPICAL ONE HOUR WALL CONSTRUCTION, UNPROTECTED OPENING ALLOWED TYPICAL ONE HOUR FIRE PARTITION, PROTECTED OPENINGS REQUIRED

TYPICAL ONE HOUR DWELLING UNIT SEPARATION, PARTY WALL CONSTRUCTION UNLESS NOTED OTHERWISE.

TWO HOUR FIRE WALL CONSTRUCTION

CONTRACTOR TO INSTALL PLEXIGLAS AT BALCONIES ON LEVELS 3 AND 4, AS DETERMINED BY NOISE CONTROL REQUIREMENTS. REFER TO REPORT PA-12 FC-2B, ADDENDUM TO PRIOR NOISE STUDY AND EIR PREPARED BY DUDEK. PROVIDE 6' HIGH PLEX-GLASS BARRIER AT BALCONIES AT 3rd AND 4th LEVELS AT BUILDING NUMBERS 11, 12, 21 & 29, FROM SR-125 NOISE AND BUILDING NUMBERS 16 - 19 FROM BRT NOISE PER REPORT.

## UNIT 6 AREA CALCULATIONS

4 BEDROOM / 3.5 BATH FIRST FLOOR SECOND FLOOR 525 SF

THIRD FLOOR 665 SF FOURTH FLOOR FIRST FLOOR PORCH SECOND FLOOR TERRACE 104 SF • THIRD FLOOR TERRACE 104 SF TOTAL OUTDOOR NOTE: CALCULATED FROM EXTERIOR FACE OF UNIT WALL

AND EXCLUDES AREAS FOR VERTICAL SHAFTS

A760

BUILDING
DRIVE SUITE 305 HERITAGE 4350 EXECUTIVE D

07/14/2016 REVISIONS

Revisions:

PLAN CHECK# CHULA VISTA BR16-0014 THROUGH 0017

Sheet Title: UNIT 6 FLOOR PLANS

> 1/4" = 1'-0" Drawn By: